


- 5" × 18' SQ STEEL POLE W/ TWIN FIXTURES
- 5" × 18" SQ STEEL POLE W/ SINGLE FIXTURE
- 5" ROUND × 20' STEEL POLE W/ TRIPLE FIXTURES
- 5" ROUND × 20' STEEL POLE W/ TWIN FIXTURES
- 16" "T" FITTERS TO MOUNT TO EXISTING TENNONS W/ TWIN FIXTURES
- $54" \times 4 I/2" \Phi$ "T" FITTERS TO MOUNT TO EXISTING POLES W/ TWIN FIXTURES
- $78" \times 4 \text{ I/2"} \text{ } \text{ } \text{"T" FITTERS TO MOUNT TO EXISTING POLES W/ TWIN FIXTURES}$
- SAME AS (F) BUT FIXTURES MOUNTED AT 90° TO EACH OTHER
- 5" × 20' SQ STEEL POLE WITH SINGLE FIXTURE.
- 5" × 20' SQ STEEL POLES W/ TWIN FIXTURES
- TWIN FIXTURES WITH ARMS. POLE WILL HAVE TO BE OUT TO 20' AND DRILLED TO ACCEPT THE NEW ARMS
- 5" × 18' SQ STEEL POLES W/ TRIPLE FIXTURES
- $24" \times 5"$ SQ "T" FITTERS TO MOUNT TO EXISTING POLES W/ TWIN FIXTURES CUT POLES TO MATCH EXISTING ON LOT
- SAME AS (J)
- 5" × 20' SQ STEEL POLES W/ THREE ARMS AT 90°. REUSE EXISTING FIXTURES.

POLE AND FIXTURE NOTES FOR INDIVIDUAL DEALERSHIPS

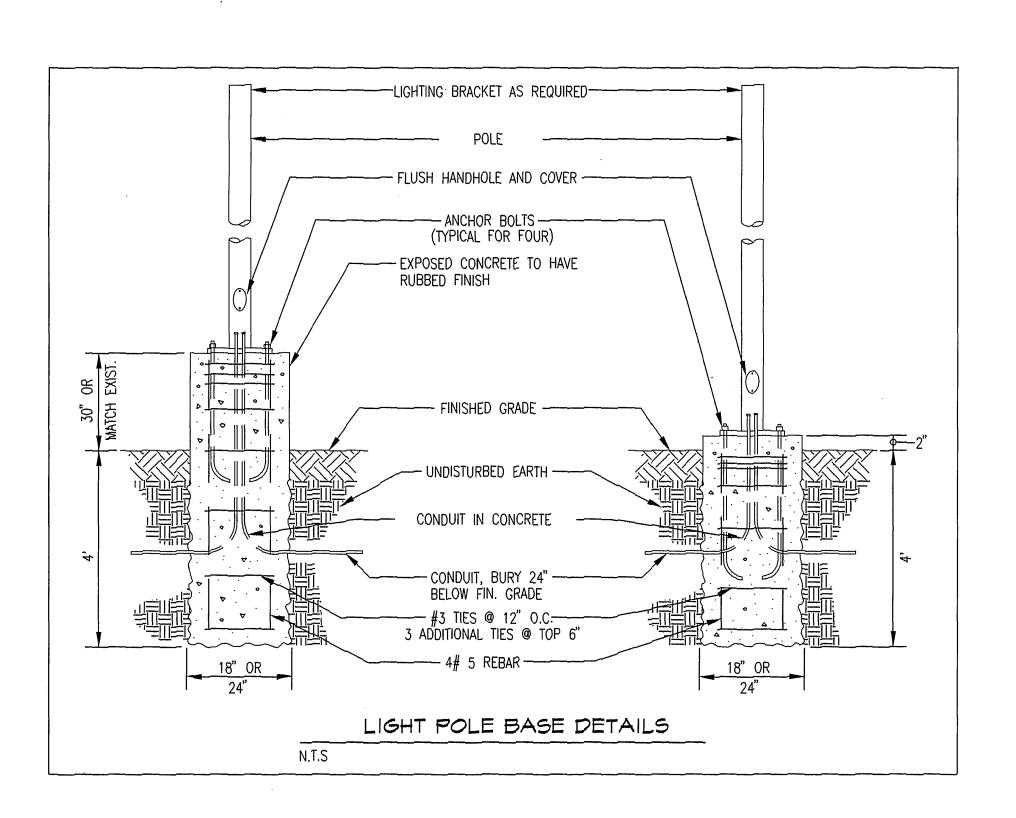

STRUCTURAL CALCULATION ARE PROVIDED ON SEPERATE SHEETS.

- 1. PROVIDE ALL MATERIALS AND LABOR AS REQUIRED TO ACHIEVE A COMPLETE AND OPERATING SYSTEM,
- 2. COORDINATE AND OBTAIN APPROVALS FROM ALL RESPECTIVE UTILITY COMPANIES AS REQUIRED FOR A COMPLETE AND OPERATING INSTALLATION.
- 3. INSTALL RACEWAY SYSTEMS AS FOLLOWS: a. USE RIGID GALVANIZED STEEL IN ALL AREAS EXPOSED TO PHYSICAL DAMAGE. b. USE COMPRESSION TYPE FITTINGS FOR ELECTRICAL METALLIC TUBING WHERE UTILIZED. c. USE P.V.C. CONDUIT UNDERGROUND WITH CODE SIZED GROUND.
- 4. ALL NEW WIRING SHALL BE COPPER TYPE "THHN/THWN" U.O.N..
- 5. CONDUIT FOR ROOF MOUNTED EQUIPMENT SHALL BE ROUTED BELOW THE ROOF WITHIN THE BUILDING.
- ALL FIXTURE, DEVICE, ETC... LOCATIONS SHALL BE VERIFIED WITH ARCH. DRAWINGS AS WELL AS EQUIPMENT SUPPLIER REQUIREMENTS PRIOR TO ANY ROUGH-IN WORK.
- 7. ALL LIGHTING FIXTURES SHALL BE MOUNTED AND SUPPORTED IN ACCORDANCE WITH OSHA STANDARDS AND ALL NATIONAL AND LOCAL ELECTRICAL CODES.
- THESE DRAWINGS ARE DIAGRAMMATIC AND REPRESENT THE INTENT OF EQUIPMENT, DEVICES, ETC... TO BE CONNECTED AND THE CIRCUITS TO WHICH THEY ARE TO BE CONNECTED TO. CONTRACTOR SHALL INSTALL ALL CONDUIT, J-BOXES, ETC ... AS REQUIRED FOR A COMPLETE AND OPERATING SYSTEM.
- ALL EXTERIOR EQUIPMENT SHALL BE WEATHERPROOF.
- 10. ELECTRICAL CONTRACTOR SHALL PERFORM ALL WORK IN STRICT ACCORDANCE WITH ALL LOCAL AND NATIONAL GOVERNING CODES.
- 11. ALL EQUIPMENT SHALL BE NEW AND BEAR A "UL" LABEL U.O.N..
- ELECTRICAL CONTRACTOR SHALL SECURE AND PAY FOR ALL NECESSARY BUILDING PERMITS.
- COMPLETE ELECTRICAL INSTALLATION SHALL BE GUARANTEED IN WRITING FOR A PERIOD OF (1) YEAR - U.O.N..
- 14. ELECTRICAL CONTRACTOR SHALL VISIT SITE PRIOR TO BID DATE, TO VERIFY ALL EXISTING CONDITIONS TO BE ENCOUNTERED IN THE INSTALLATION OF ALL NEW EQUIPMENT, FIXTURES DEVICES, FEEDERS, ETC.. EXACT INSTALLATION METHOD AND REQUIREMENTS SHALL BE VERIFIED AND DETERMINED PRIOR TO BID DATE, CONTRACTORS SHALL IMMEDIATELY NOTIFY THIS ENGINEER OF ANY REQUIRED MODIFICATIONS WHICH ARE NOT SHOWN ON THESE DRAWINGS. SUBMITTAL OF BID INDICATES CONTRACTOR IS COGNIZANT OF ALL JOB SITE CONDITIONS AND WORK TO BE PERFORMED.
- 15. ALL EQUIPMENT ELECTRICAL CHARACTERISTICS, LOCATIONS, AND CONNECTION REQUIREMENTS SHALL BE VERIFIED PRIOR TO ANY ROUGH-IN WORK.
- 16. ELECTRICAL CONTRACTOR SHALL FURNISH THE FOLLOWING SHOP DRAWINGS FOR PRIOR APPROVAL:
 - a. ALL ELECTRICAL DISTRIBUTION EQUIPMENT AND PANELBOARDS.
 - b. PULL BOXES, RELAYS, TIME CLOCKS & CONCRETE MIX DESIGN.
- 17. THESE ITEMS SHALL BE APPROVED BY THIS OFFICE PRIOR TO ANY COMMENCEMENT OF PLACING ORDERS OR PERFORMING ANY ROUGH-IN WORK.
- COMPLETE ELECTRICAL SYSTEM SHALL BE GROUNDED IN ACCORDANCE WITH THE PRESENTLY ADOPTED
- 19. PROVIDE ENGRAVED PLASTIC NAMEPLATES FOR ALL ELECTRICAL EQUIPMENT.
- 20. PROVIDE THE OWNERS AND THIS ENGINEER WITH ONE SET OF ELECTRICAL "AS-BUILTS" AT THE COMPLETION OF JOB.
- 21. LIGHTING RELAYS TO BE GE. # CR353ADXBA1, WHERE X= # OF POLES, OR EQUAL BY SQ. D.
- 22. ON SITE TRENCHING SHALL HAVE A MINIMUM COVER OF 24" TO FINISH GRADE, CONTRACTOR SHALL BACKFILL ALL TRENCHING UNDER ASPHALT WITH 2 SACK SLURRY MIX TO 1" FROM EXISTING ASPHALT GRADE. CAP TRENCH WITH ASPHALT.
- 23. CONTRACTOR SHALL INCLUDE ALL WIRE, CONDUIT, ETC. FOR A COMPLETE SYSTEM. THIS INCLUDES THE REWORKING OF EXISTING CIRCUITS. ASSUME THAT THE WIRING IS INTACT FROM THE PANELS TO THE FIRST POLE LOCATION. FROM THERE THE RESPONSIBILITY IS THE CONTRACTORS TO PROVIDE NEW CONDUIT AND WIRE TO MATCH EXISTING. THE BASE BID WILL INCLUDE ALL THESE COSTS.
- 24. LIGHT FIXTURES ARE TO MATCH EXISTING AND WILL NOT BE SUBSTITUTED. FOR PRICING INFORMATION

FRB & ASSOCAITES 5021 LAKE HARBOR ROAD MUSKEGON, MI 49441 (616) 798-3602 FAX (616) 798-3810 FACTORY LEAD TIME.


.25. AT ELECTRICAL CONTRACTORS RELEASE ALL LIGHTS AND POLES ARE REQUIRED TO BE SHIPPED TO EACH INDIVIDUAL DEALER FOR TEMPORARY STORAGE AT A LOCATION ON THE DEALERS PROPERTY TO BE DETERMINED BY EACH DEALER. SAID CONTRACTOR SHALL ALLOW 4 TO 6 WEEKS FOR

GENERAL NOTES AND SPECIFICATIONS

FILE W/R-3471

Underground Service Alert call: TOLL FREE - 4133 TWO WORKING DAYS BEFORE YOU DIG

PRIVATE ENGINEERING NOTE

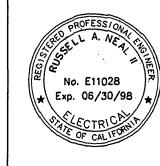

DESIGN

WEST COAST DESIGN ELECTRICAL AND LIGHTING ENGINEERS 26692 PASEO BRILLO, SUME 200 SAN JUAN CAPISTRANO, CA 92675 SCALE: (714) 240-1378 FAX 240-1782 DATE: OCTOBER 1997

BENCH MARK: RIV. CO. BM 601-21-68, CALTRANS BRASS DISK SET IN CONC. WELL LOCATED IN CENTERLINE OF MONROE STREET 40' NW OF INDIANA AVENUE ELEVATION: 810.933

DESIGNED BY

REVISIONS

DRAWN BY_

CHECKED BY

APPROVED BY BY DATE APPROVED BY PRINCIPAL ENGR. PARK DEPARTMENT DIRECTOR OF PUBLIC WORKS APPR. DATE TRAFFIC DIVISION CHIEF P.W.ENGR.

CITY OF RIVERSIDE,

DEPARTMENT OF PUBLIC WORKS

DATE

AUTO CENTER RENOVATION PLAN SHEET DETAILS AND NOTES

IN THE CITY OF RIVERSIDE, COUNTY OF RIVERSIDE


STATE OF CALIFORNIA

FOR: RIVERSIDE AUTO CENTER ASSESSMENT DISTRICT

INDEXED 12-26-01 4H

PROJECT NO.

OF 13

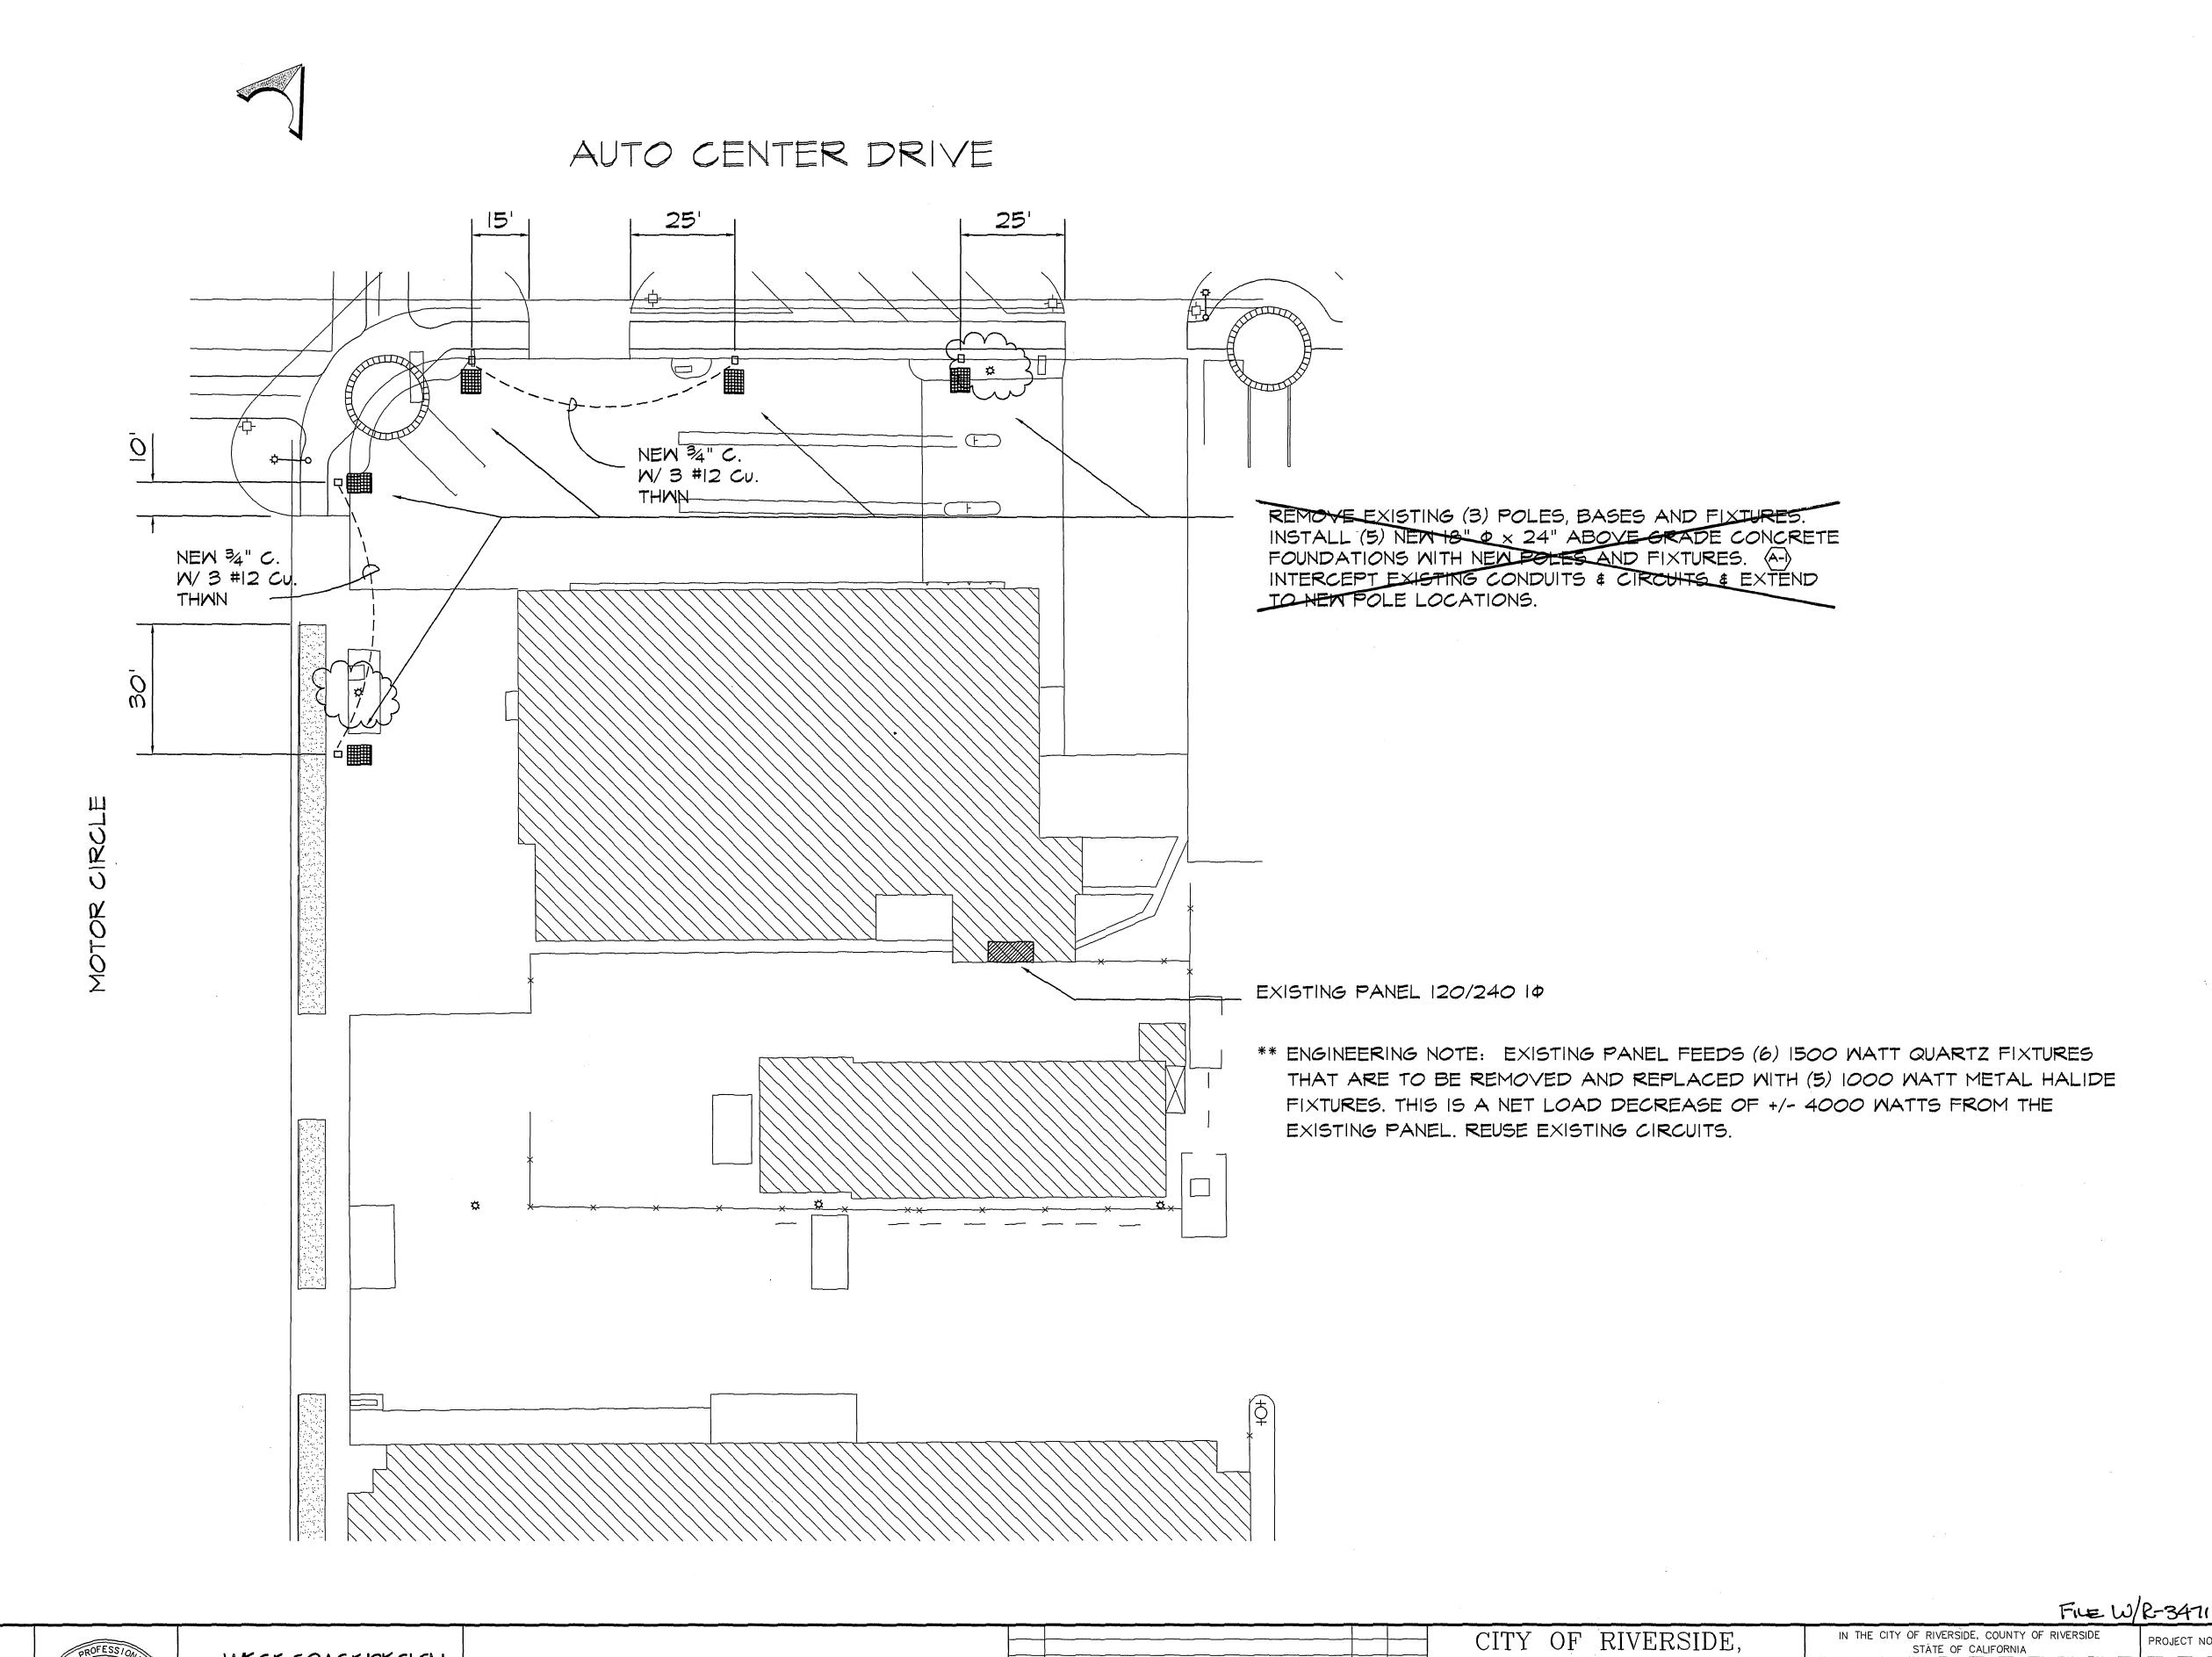

Underground Service Alert
Call: TOLL FREE

1 - 800

422 - 4133 TWO WORKING DAYS BEFORE YOU DIG

PRIVATE ENGINEERING NOTE

No. E11028 Exp. 06/30/98

WEST COAST DESIGN ELECTRICAL AND LIGHTING ENGINEERS 26692 PASEO BRILLO, SLIME 200 COAST DESIGN

SAN JUAN CAPISTRANO, CA 92675 (714) 240-1378 FAX 240-1782 DATE: OCTOBER 1997

BENCH MARK: RIV. CO. BM 601-21-68, CALTRANS BRASS DISK SET IN ELEVATION: 810.933

REVISIONS

DEPARTMENT OF PUBLIC WORKS APPROVED BY BY DATE APPROVED BY PRINCIPAL ENGR.


PARK DEPARTMENT

APPR. DATE TRAFFIC DIVISION

AUTO CENTER RENOVATION PLAN SHEET CAR WASH 8190 AUTO CENTER DRIVE DIRECTOR OF PUBLIC WORKS

DL-2LIGHTING PLAN of <u>13</u> FOR: RIVERSIDE AUTO CENTER ASSESSMENT DISTRICT

IMPEXED 12-26-01 4th

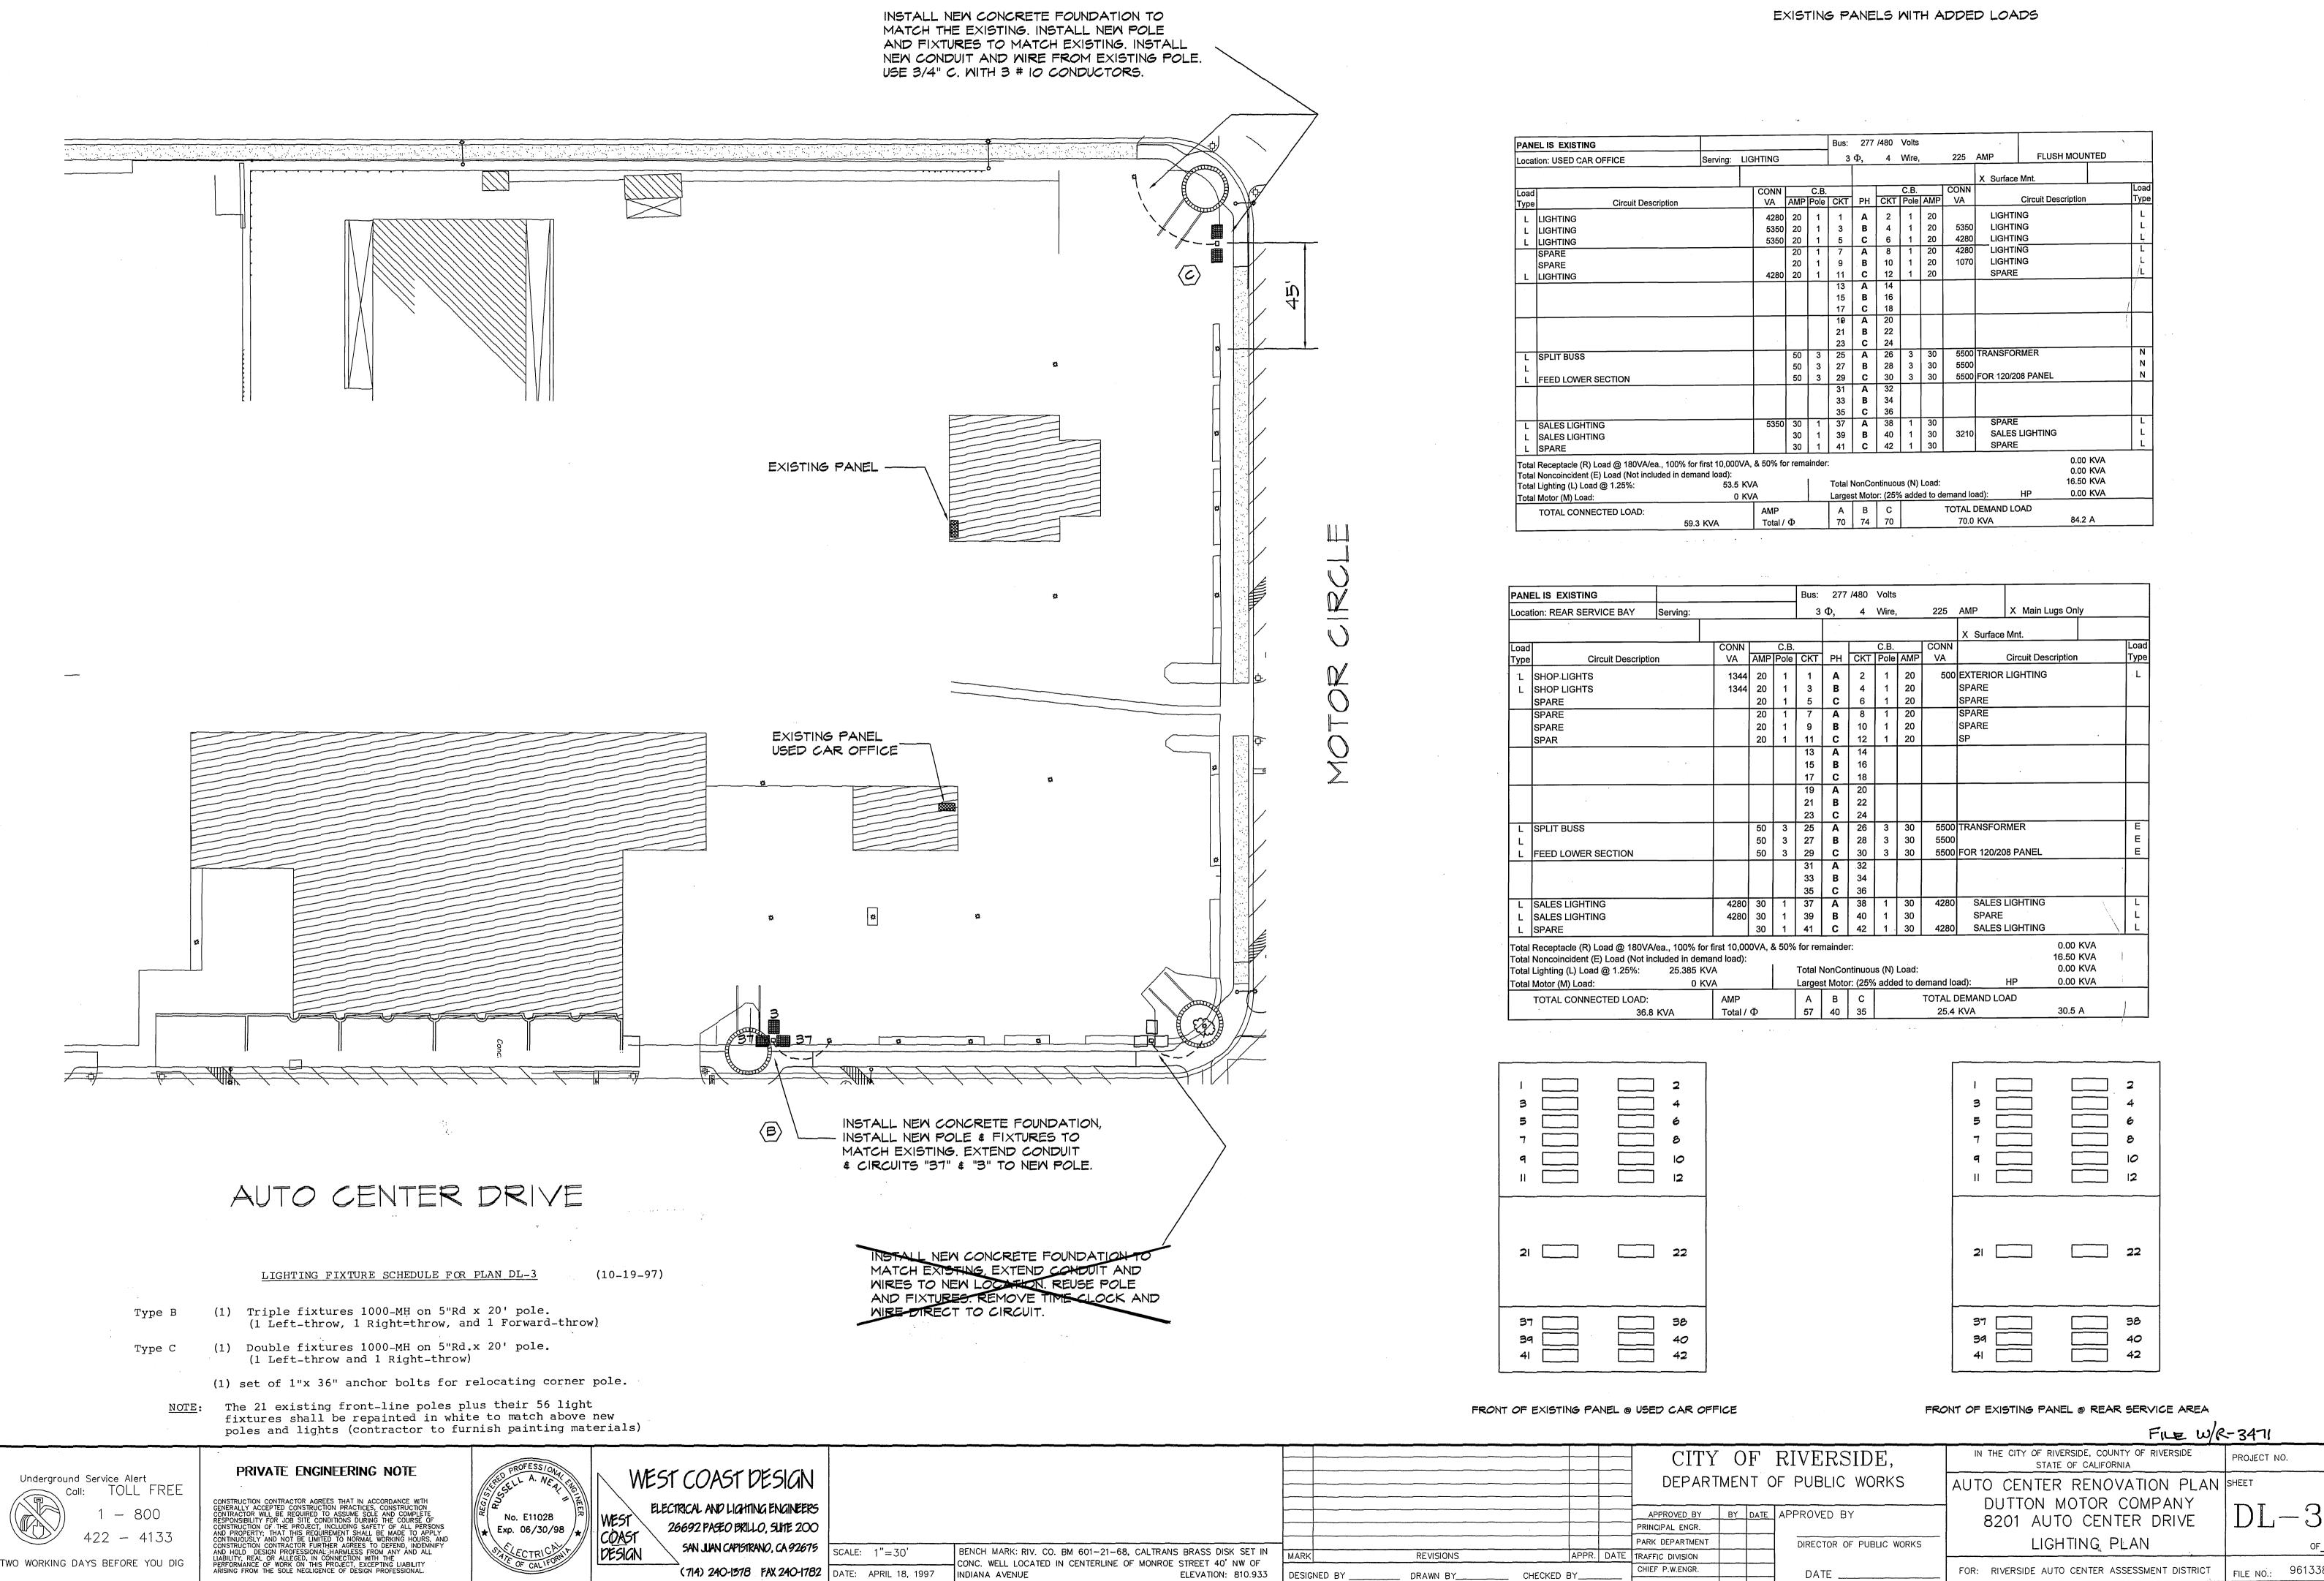

SE-SE OC IN HE SE INVITAMOTHAN OF

INDEXED 12-26-01 4H

CONC. WELL LOCATED IN CENTERLINE OF MONROE STREET 40' NW OF

ELEVATION: 810.933 DESIGNED BY

(714) 240-1578 FAX 240-1782

DATE: MARCH 1997

INDIANA AVENUE

TWO WORKING DAYS BEFORE YOU DIG

REVISIONS

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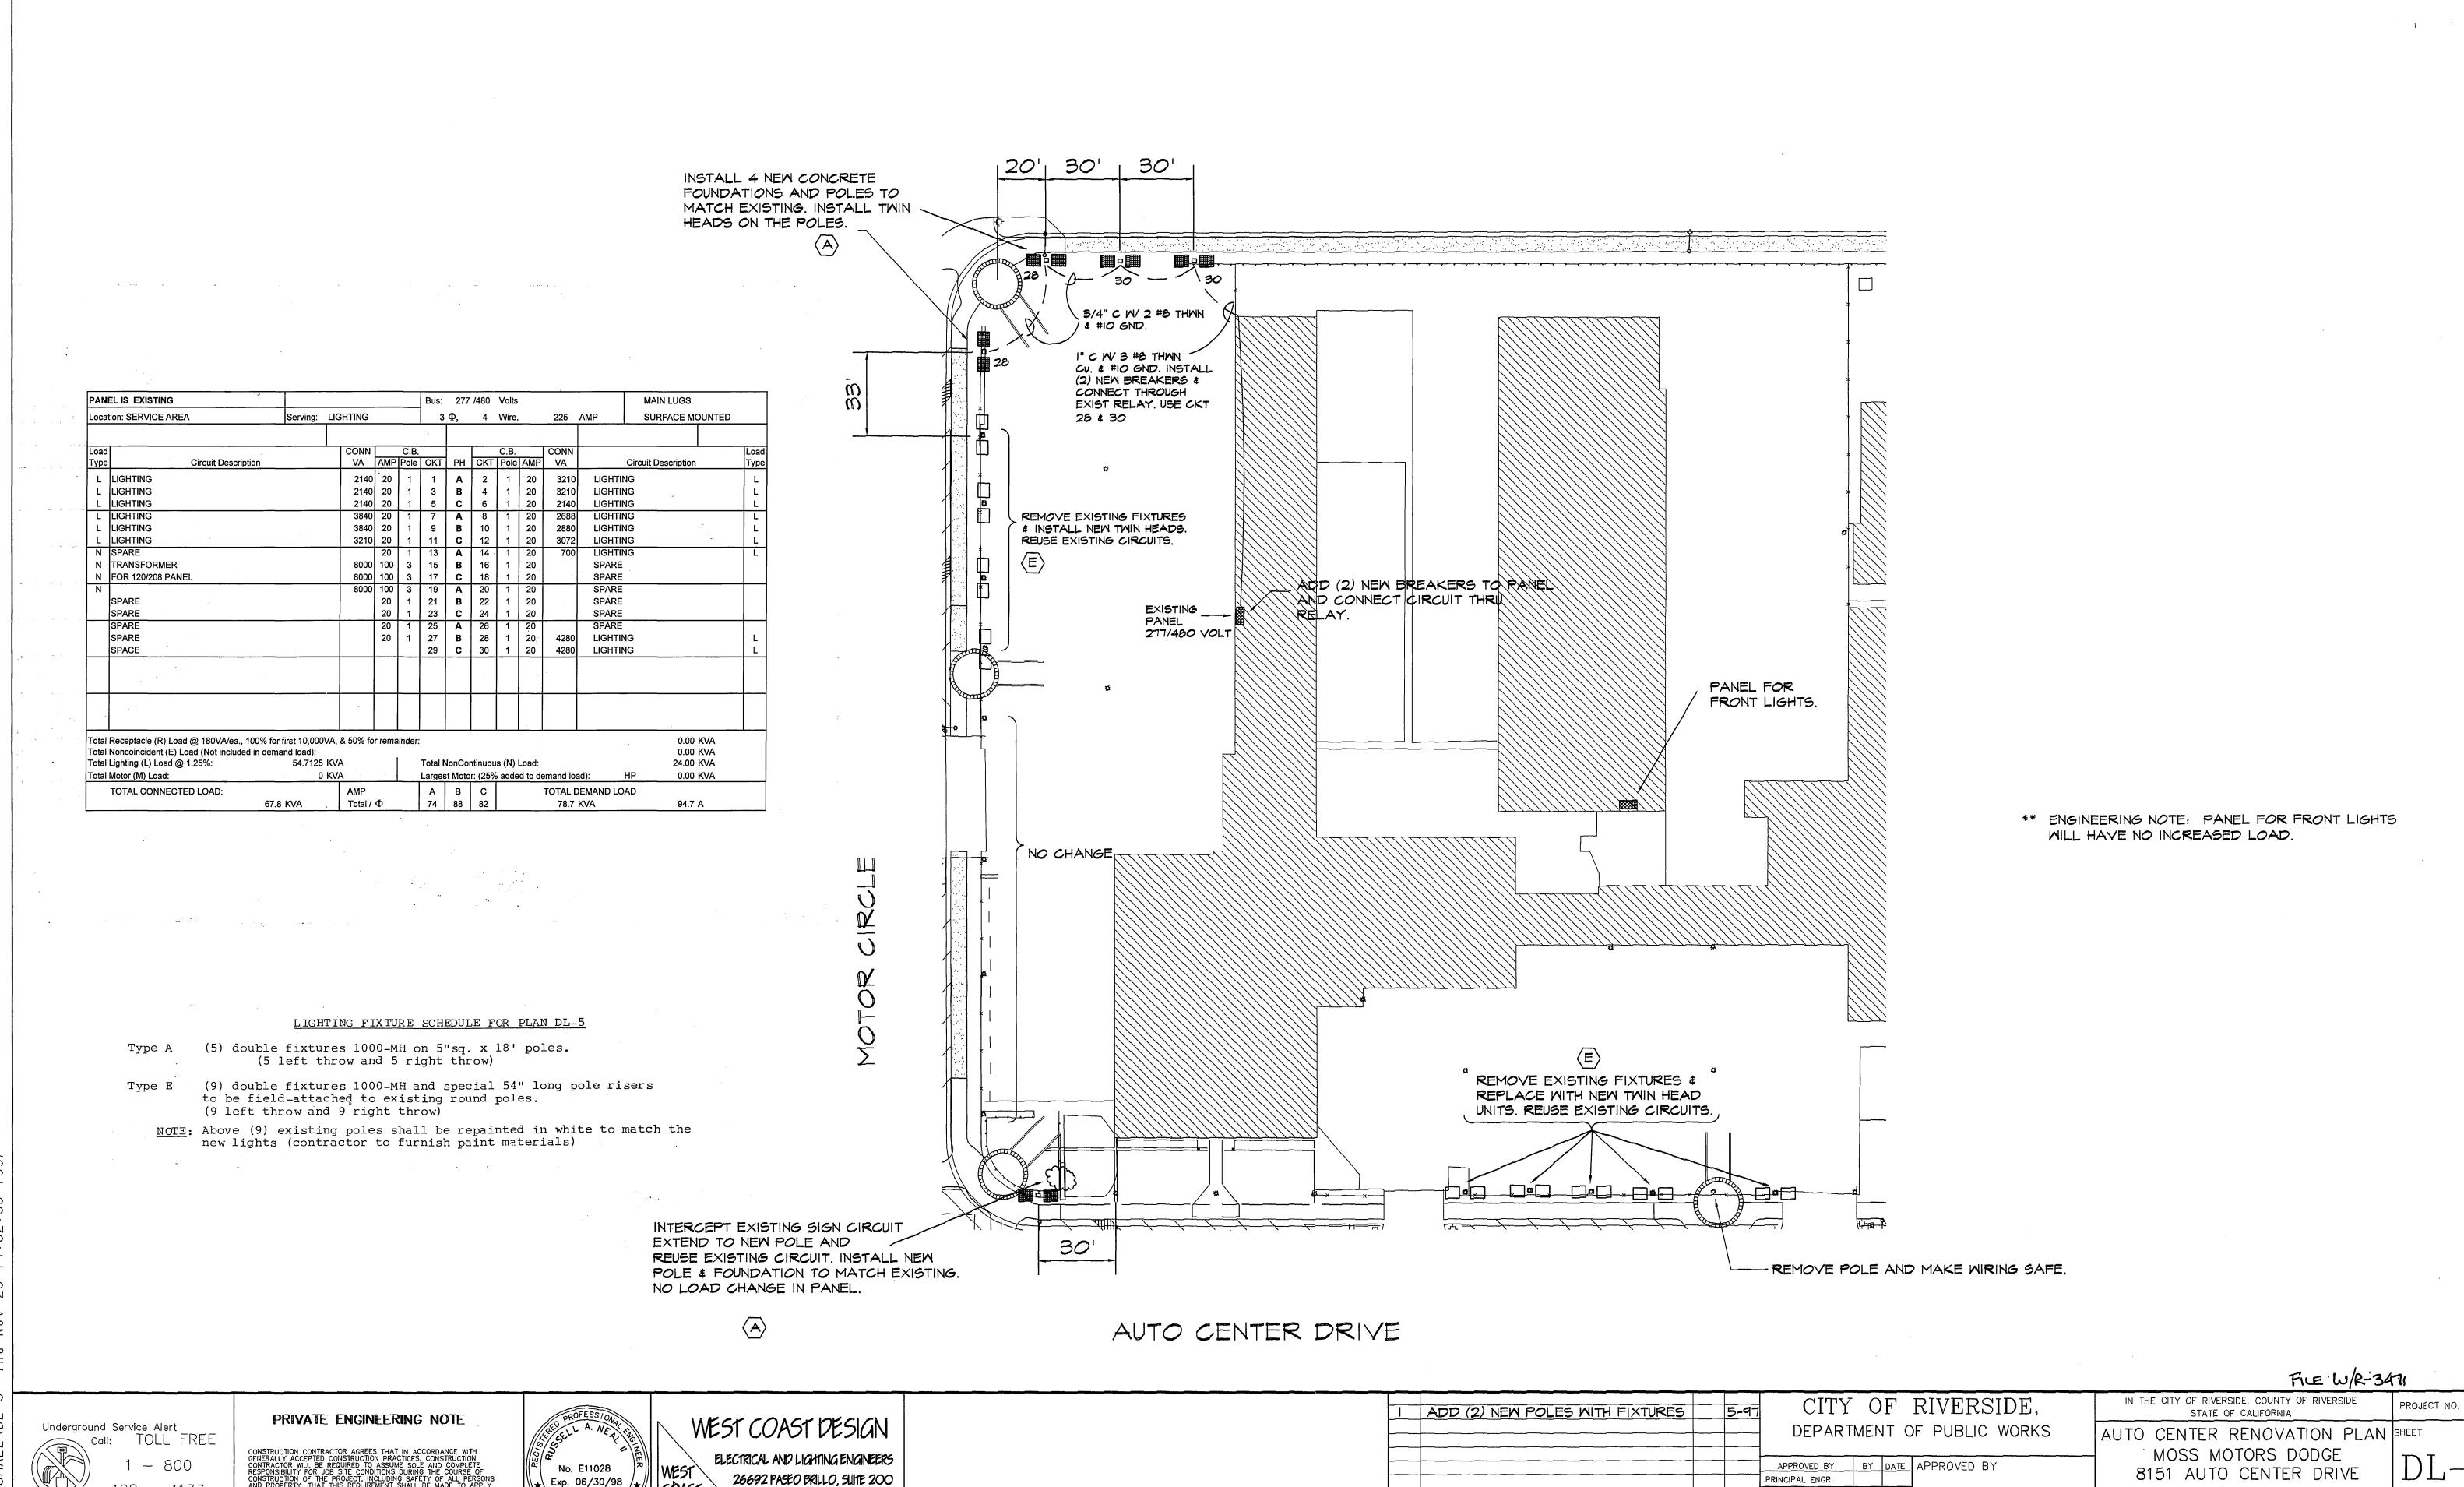
APPR. DATE TRAFFIC DIVISION

CHECKED BY_

CHIEF P.W.ENGR.

INDEXED 12-26-01 4H

FOR: RIVERSIDE AUTO CENTER ASSESSMENT DISTRICT



BENCH MARK: RIV. CO. BM 601-21-68, CALTRANS BRASS DISK SET IN

ELEVATION: 810.933

CONC. WELL LOCATED IN CENTERLINE OF MONROE STREET 40' NW OF

PRINCIPAL ENGR.

PARK DEPARTMENT

CHIEF P.W.ENGR.

APPR. DATE TRAFFIC DIVISION

CHECKED BY_

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DRAWN BY_

DIRECTOR OF PUBLIC WORKS

LIGHTING PLAN

FOR: RIVERSIDE AUTO CENTER ASSESSMENT DISTRICT

INDEXED 12-26-01 LFH

TWO WORKING DAYS BEFORE YOU DIG

Exp. 06/30/98

COAST DESIGN

SAN JUAN CAPISTRANO, CA 92675 | SCALE: 1"=30"

(714) 240-1378 FAX 240-1782 DATE: APRIL 18, 1997

PANE	L NO. UNKNOWN	SECTION 1	OF	1		Bus:	277	/480	Volts				X Main	C.B.,		AMF
ocati	on: SERVICE AREA	Serving: LIGH	HTING			3	Φ,	4	Wire,		100	AMP	Main	Lugs Only		
	Integrated Equipment SC Ra		Feed Th	ru Lug	 S							Flush M			Top Fe	
	35,000 RMS SY	M AMPS	SubFeed	Lugs				Iso. G		is	<u> </u>	X Surface	Mnt.		Bot. Fe	
Load			CONN		C.B.	0.0	5	0.7	C.B.	ANAD	CONN		Circuit De	porintion		Loa
Гуре	Circuit Descripti	on	VA	AMP	Pole	СКТ	PH	СКТ	Pole	AMP	VA			Scription		1 yp
N	15 KVA TRANSFORM	ER	4500	30	3	1	Α	2	3	20		SPARE				L
N	FOR		4500	30	3	3	В	4	3	20		SPARE				-
N	SERVICE AREA POWI	ER	4500	30	3	5	С	6	3	20		SPARE				<u> </u>
L	SPARE			20	1	7	Α	8	1	20	2140		LIGHTS			-
L	SHOP LIGHTS		1920	20	1	9	В	10	1.	20	1070		LIGHTS			
L	SHOP LIGHTS		2304	20	1	11	С	12	1	20	2140		LIGHTS			<u> </u>
L	SALES LIGHTS		2140	20	1	13	Α	14	1	20	4280	1	LIGHTS			-
L	SALES LIGHTS		2140	20	1	15	В	16	1	20	4280		LIGHTS			
L	SALES LIGHTS		2140	20	1	17	С	18	1	20	2140		LIGHTS			<u> </u>
L	SALES LIGHTS		3840	20	1	19	Α	20	1	20	1920	* * * * * * * * * * * * * * * * * * * *				
L	SALES LIGHTS		4180	20	1	21	В	22	1	20		SPARE				
L	SALES LIGHTS		4180	20	1	23	С	24			ļ	SPACE				-
L	SALES LIGHTS		4180	20	1	25	Α	26			1	SPACE				1
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L	SPACE					29	С	30				SPACE				+-
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						37	A	38								
				1		39	В	40								
				<u> </u>		41	С	42		<u> </u>						Щ.
Total Receptacle (R) Load @ 180VA/ea., 100% for first 10,000VA, & 50%					for re	mainde	er:						0.00 K			
	Noncoincident (E) Load (Not in	ncluded in dema	and load):											0.00 K		
Total I	Lighting (L) Load @ 1.25%:	61.4675 KV			}			ntinuo						13.50 K		
Total I	Motor (M) Load:	0 KV	Ά		L	Larges	st Moto	or: (25%	6 adde	d to d	emand lo	oad):	HP	0.00 K	/A	
	TOTAL CONNECTED LOAD:		AMP			Α	В	С			TOTAL I	DEMAND LO	DAD			
		7 KVA	Total /	Φ		83	80	63			75.0	KVA		90.2 A		

LIGHTING FIXTURE SCHEDULE FOR PLAN DL-6


Type A (8) double fixtures 1000-MH on 5"sq.x 18' poles. (8 left throw and 8 right throw)

(1) same as above except pole to have an opening for electrical convenience outlet (contractor to furnish outlet and cover)(1 left throw and 1 right throw)

Type F (10) double fixtures 1000-MH with special 78" long pole risers to be field-attached to existing poles. (10 left throw and 10 right throw). Fixtures in 180° configuration.

Type G (1) double fixtures 1000-MH with special 78" long pole riser in 90° configuration to be field attached to existing pole. (1 left throw and 1 right throw)

NOTE: Above (11) type "F" and "G" poles shall be repainted in white to match the new lights and risers (contractor to furnish paint materials).

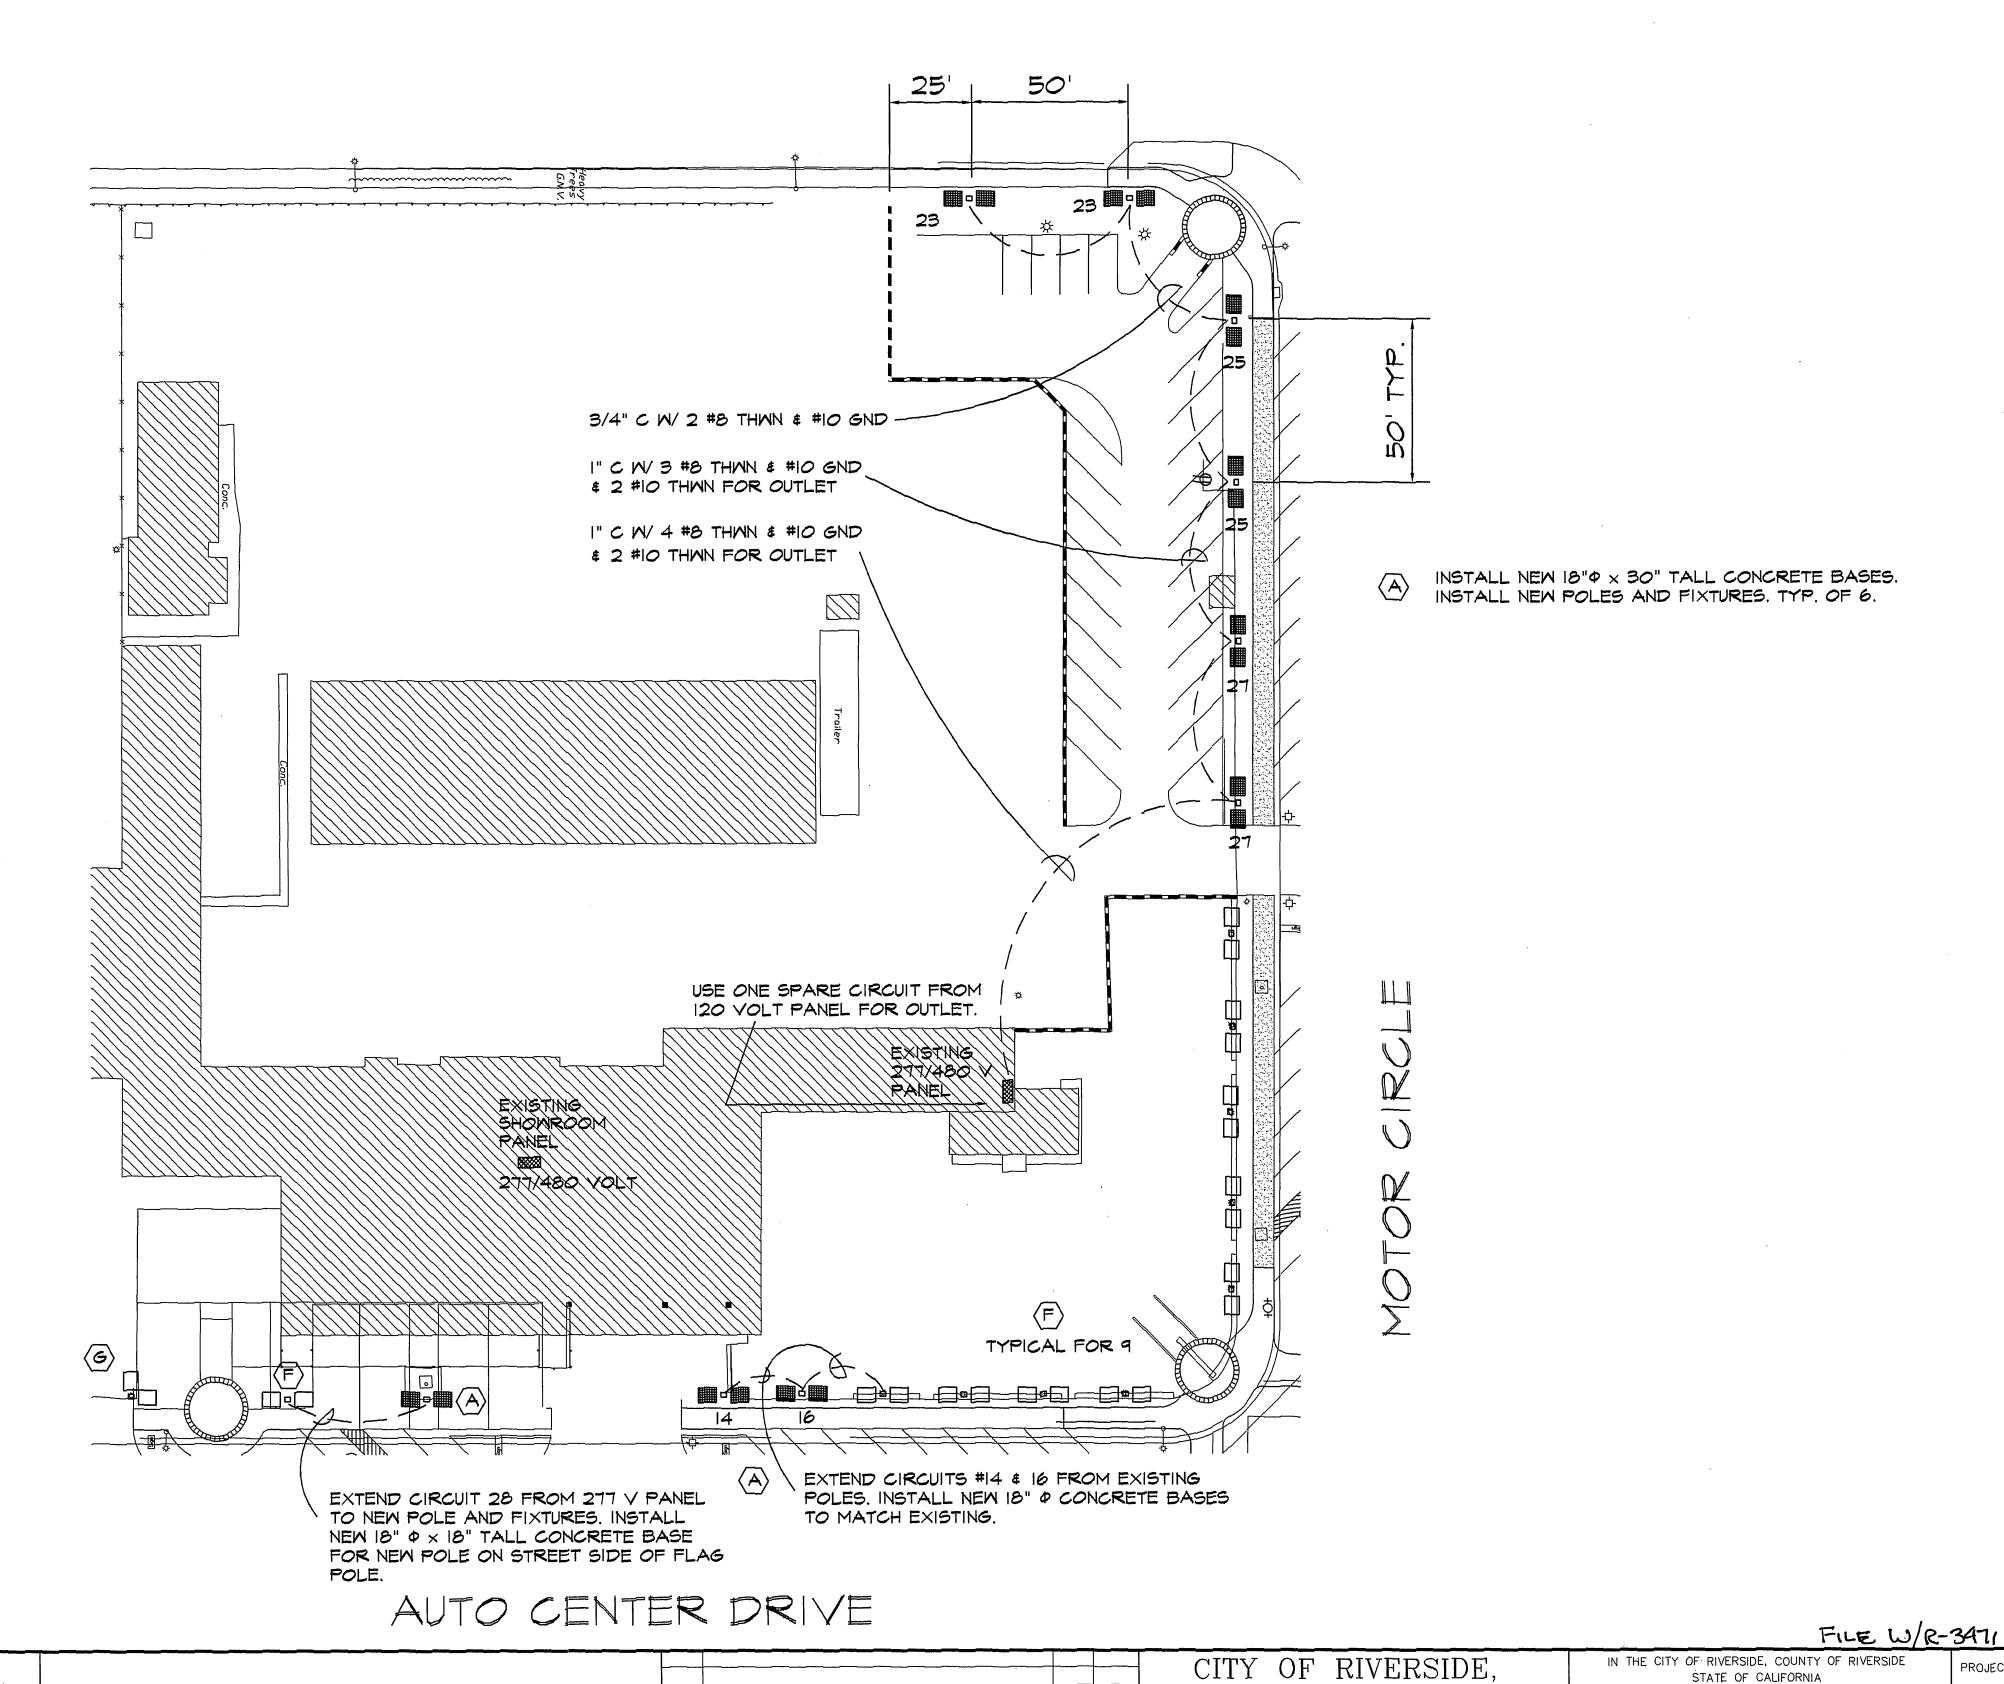

Underground Service Alert TOLL FREE

TWO WORKING DAYS BEFORE YOU DIG

PRIVATE ENGINEERING NOTE

Exp. 06/30/98 /📲 //

WEST COAST DESIGN ELECTRICAL AND LIGHTING ENGINEERS 26692 PASEO BRILLO, SLITE 200 COAST DESIGN SAN JUAN CAPISTRANO, CA 92675 (714) 240-1378 FAX 240-1782 DATE: MAY 1997

SCALE: 1"=30' BENCH MARK: RIV. CO. BM 601-21-68, CALTRANS BRASS DISK SET IN CONC. WELL LOCATED IN CENTERLINE OF MONROE STREET 40' NW OF INDIANA AVENUE

ELEVATION: 810,933


DEPARTMENT OF PUBLIC WORKS APPROVED BY DATE APPROVED BY PRINCIPAL ENGR. PARK DEPARTMENT DIRECTOR OF PUBLIC WORKS REVISIONS APPR. DATE TRAFFIC DIVISION

MULLER HOOD PONTIAC 8101 AUTO CENTER DRIVE LIGHTING PLAN FOR: RIVERSIDE AUTO CENTER ASSESSMENT DISTRICT | FILE NO .:

AUTO CENTER RENOVATION PLAN SHEET

EXISTING PANEL WITH PEAK LOAD FROM PREVIOUS 12 MONTHS OF BILLING WITH A 1.25 FACTOR PER NEC 220-35 \$ ADDED LOAD OF NEW LIGHTING.

PANEL IS EXISTING					Bus: 120 /240 Volts										
Locat	ion:	Serving:				1	Φ,	3	Wire,		200 AMP		Main Lugs Only		
	Integrated Equipment SC Ra 10000 RMS SYN											Flush M	nt.		
Load			CONN		C.B.				C.B.		CONN				Loa
Type	Circuit Descriptio	n	VA	AMP	Pole	СКТ	PH	СКТ	Pole	AMP	VA		Circuit Des	cription	Тур
N	LOADS ARE FROM HIGHEST		8675	20	1	1	A	2	1 1	20	,			•	
N	PEAK DEMAND X 125% PER		8675	20	1	- 3	В	4	1	20		:			
N	NEC 220-35			20	1	-5	Α	6	1	20					
				20	1	7	В	8	1	20		<u>.</u>			
				20	1	9.	Α	10	1	20					
				20	1	11 -	В	12	1	20					
				20	1	13	Α	14	1	20					
				20	1 .	15	В	16	1	20					_
			T	20	1 -	17	Α	18	1	20					ı
				20	1 ·	19	В	20	1	20		<u> </u>			
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	SPACE				1	23	В	24	1	40					_ _
	SPACE		-		1	25	A	26	1			SPACE	-11.10		1.
	SPACE		<u> </u>		1	27	В	28	2	20		NEW LIGHT			_ -¦
	•			20	1	29	A	30	2	20		NEW LIGHT		•	
				20	2	31	В	32	2	20		NEW LIGHT			╼┼┼
				20	2	33	A	34	2	20		NEW LIGHT			-
				20	2	35	В	36 38	2	20 20		NEW LIGHT			-
			•	30	2	37 39	A B	40	2	20	1	NEW LIGHT			-
		 	+	30	2	41	A	42	2	20		NEW LIGHT		· · · · · · · · · · · · · · · · · · ·	- -
	<u> </u>	<u> </u>				L			<u> </u>	20	1000	INCAA CIOITI			
	Receptacle (R) Load @ 180VA				& 50%	for re	mainde	er:						0.00 KVA	
	Noncoincident (E) Load (Not in					Takal I	VI==0=		(NI)	Loodi				0.00 KVA 17.35 KVA	
	Lighting (L) Load @ 1.25%: Motor (M) Load:	16.05 K 0 K	•	•			NonCo				emand lo	ad).	HP	0.00 KVA	
		UN	717	<u> </u>	<u>.</u>		$\overline{}$,, <u>(2</u> 37	Laude	, <u></u>				3.33 1.47.1	
	TOTAL CONNECTED LOAD:		AMP	. .		A	В					DEMAND LO	AD	400.0.4	`
	30.2	KVA	Total /	Φ		126	126				33.4	KVA		139.2 A	

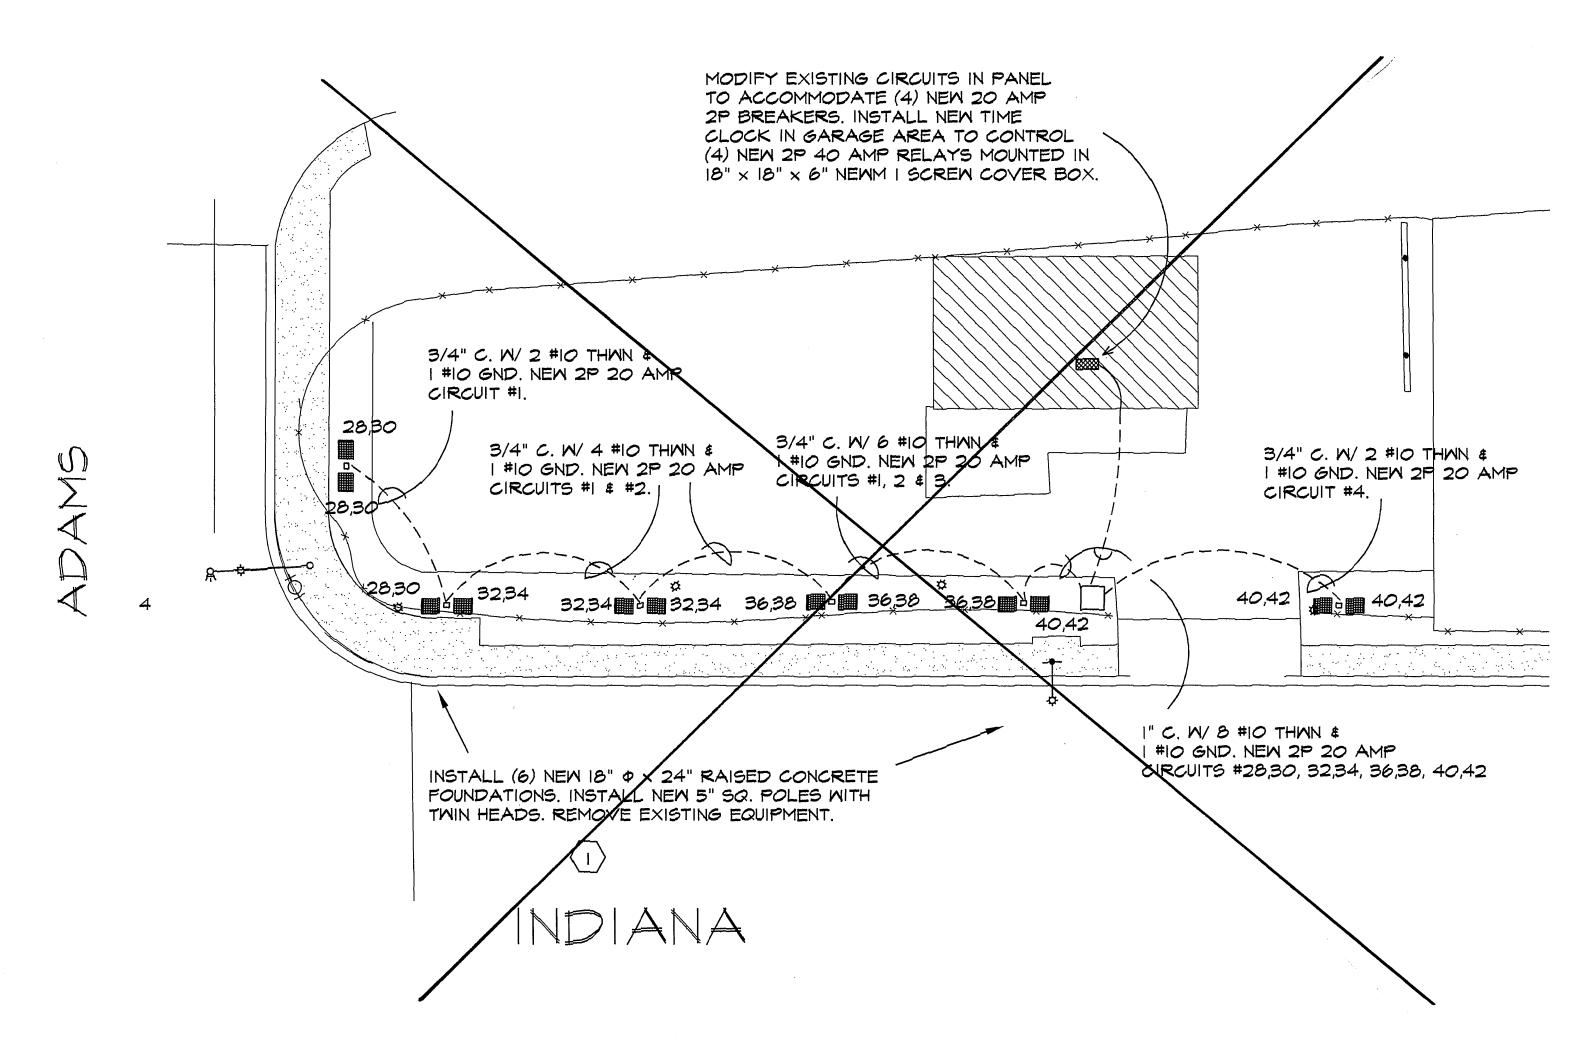


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Underground Service Alert

Call: TOLL FREE TWO WORKING DAYS BEFORE YOU DIG

PRIVATE ENGINEERING NOTE



WEST COAST DESIGN ELECTRICAL AND LIGHTING ENGINEERS WEST COAST DESIGN 26692 PASEO BRILLO, SLIME 200

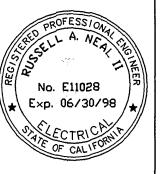SAN JUAN CAPISTRANO, CA 92675 | SCALE: 1"=20" (714) 240-1578 FAX 240-1782 DATE: APRIL 1997

BENCH MARK:

PRINCIPAL ENGR. PARK DEPARTMENT APPR. DATE MARK REVISIONS TRAFFIC DIVISION

CHECKED BY_

DRAWN BY_

CHIEF P.W.ENGR.

FILE W/R-3471 IN THE CITY OF RIVERSIDE, COUNTY OF RIVERSIDE STATE OF CALIFORNIA CITY OF RIVERSIDE, DEPARTMENT OF PUBLIC WORKS AUTO CENTER RENOVATION PLAN SHEET GMAS USED CARS APPROVED BY BY DATE APPROVED BY 8291 INDIANA AVE. LIGHTING PLAN


DIRECTOR OF PUBLIC WORKS

INDEXED 12-26-01 4H

PROJECT NO.

DL-7

OF <u>13</u>

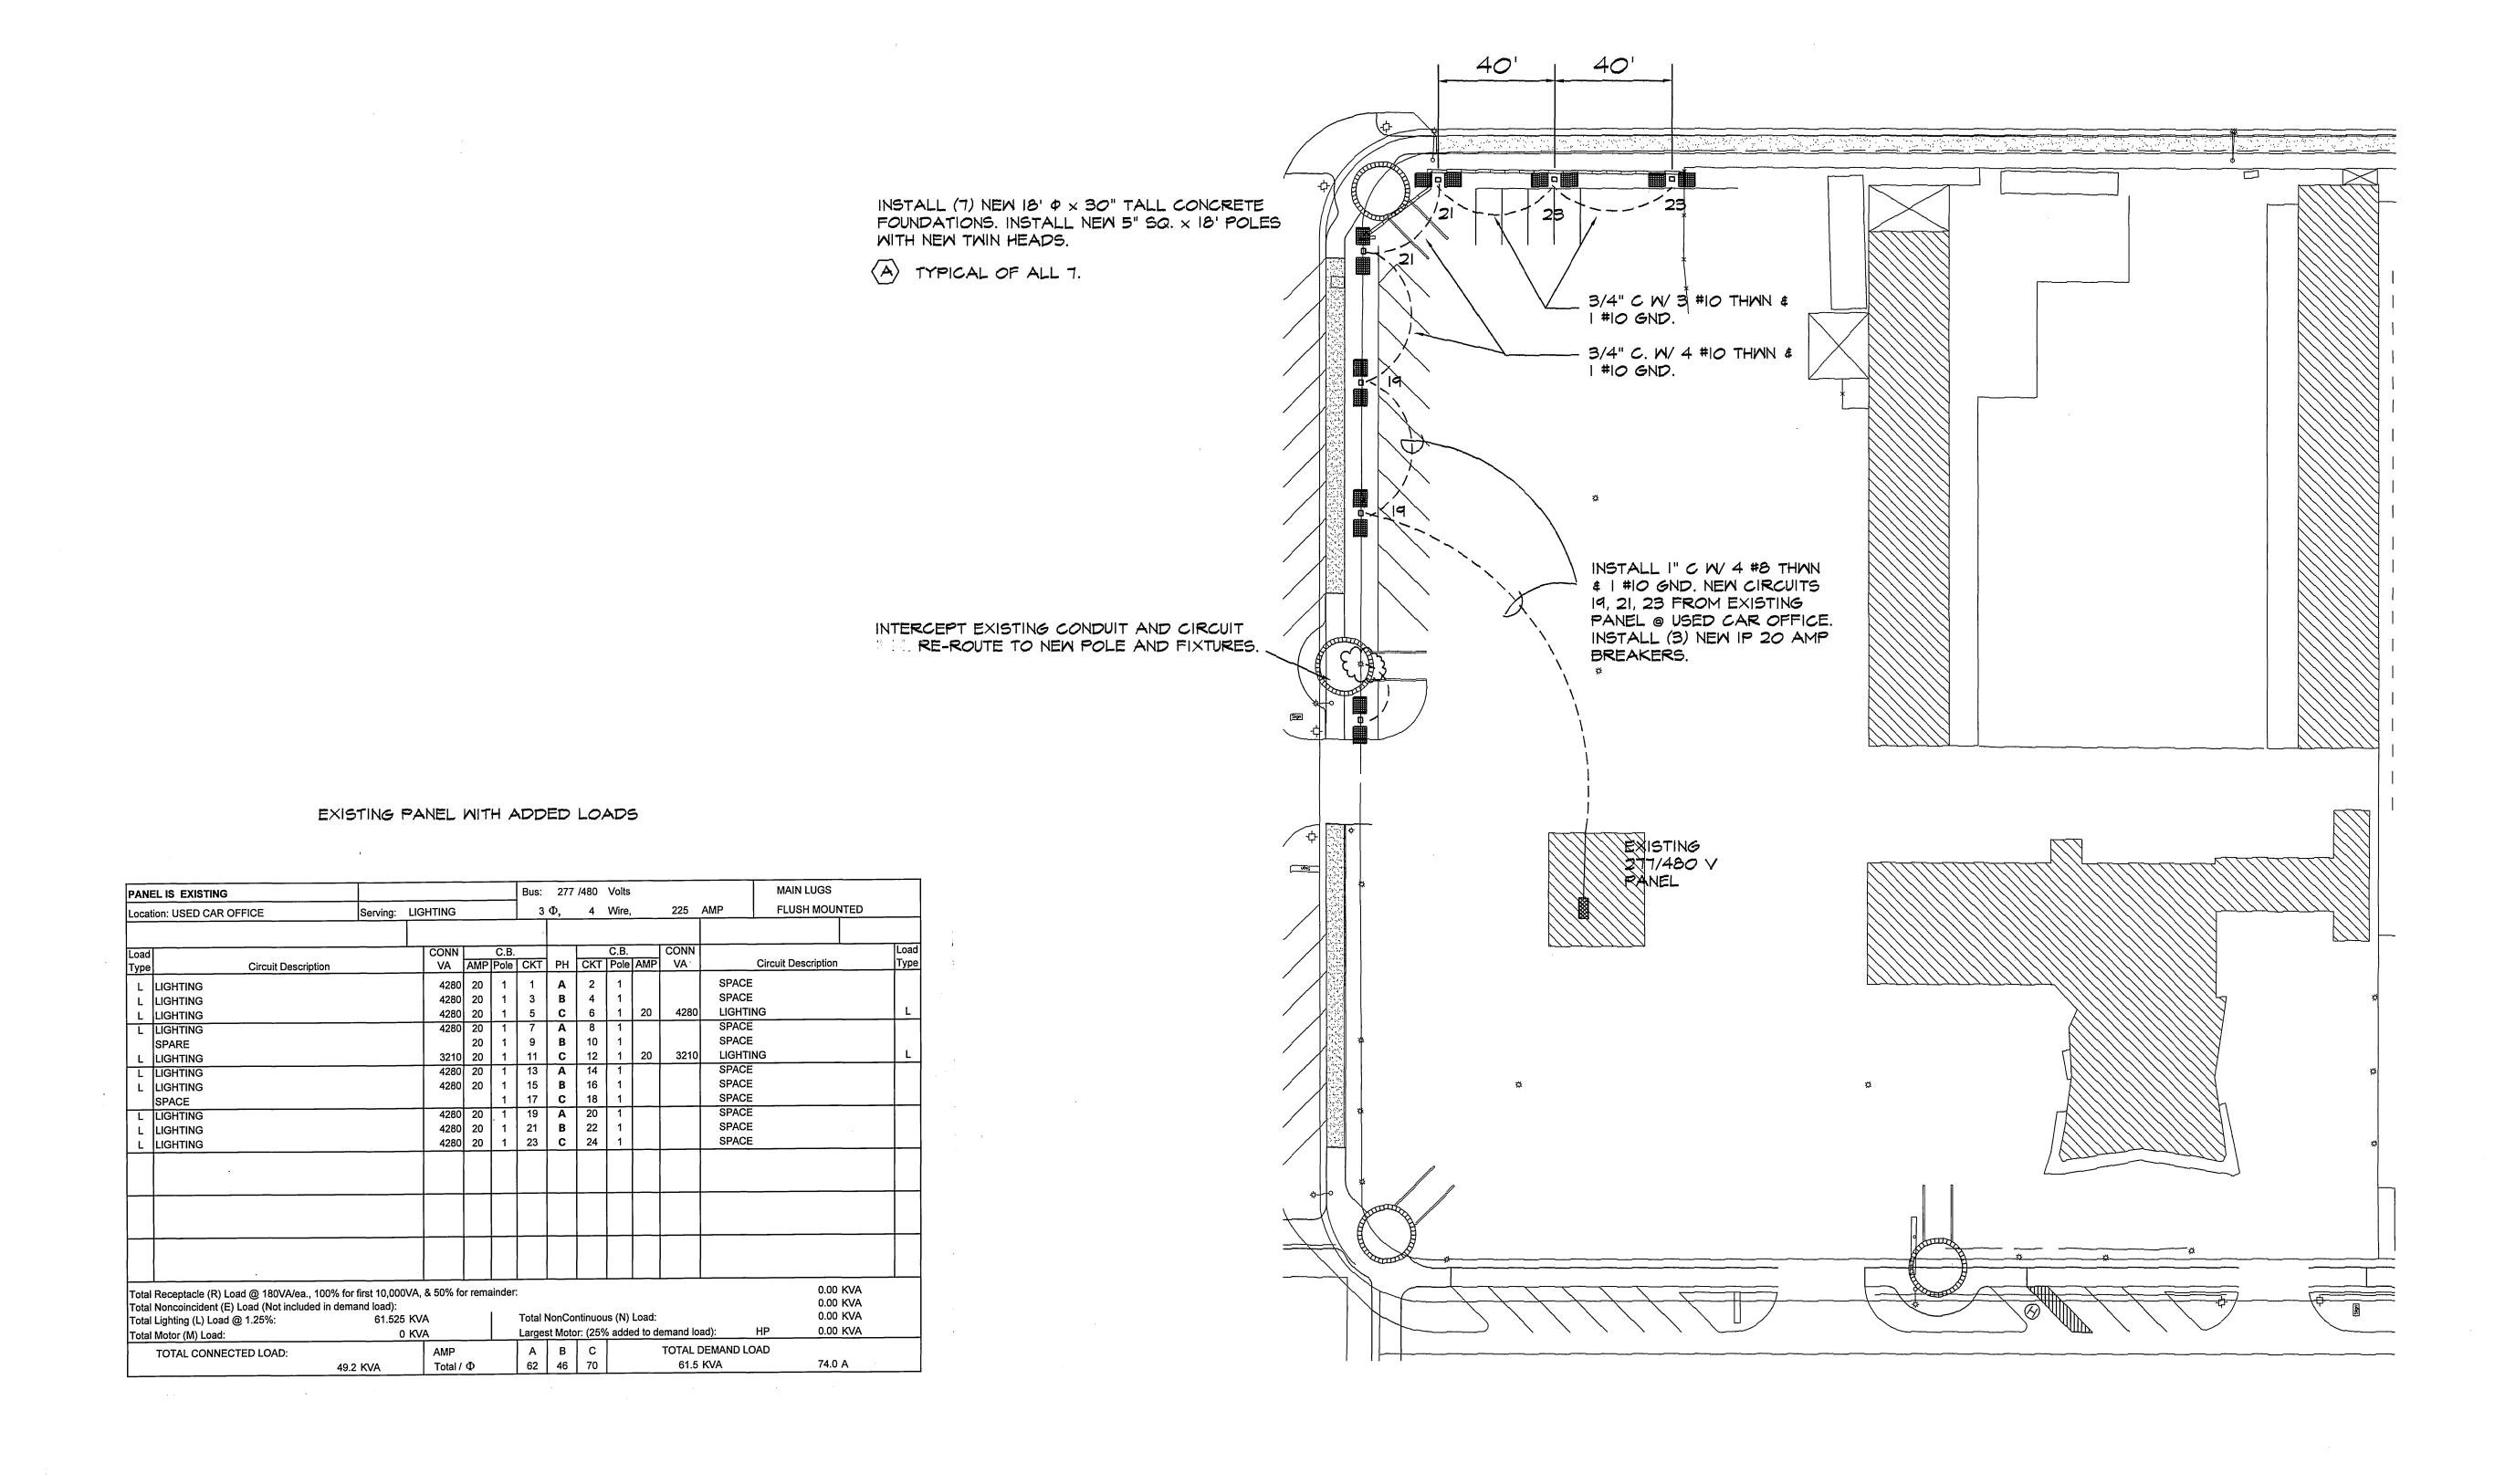

Underground Service Alert

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PRIVATE ENGINEERING NOTE

No. E11028 Exp. 06/30/98

WEST COAST DESIGN COAST DESIGN


ELECTRICAL AND LIGHTING ENGINEERS 26692 PASEO BRILLO, SLITE 200 SAN JUAN CAPISTRANO, CA 92675 (714) 240-1378 FAX 240-1782 DATE: APRIL 1997

BENCH MARK: RIV. CO. BM 601-21-68, CALTRANS BRASS DISK SET IN SCALE: 1"=30' CONC. WELL LOCATED IN CENTERLINE OF MONROE STREET 40' NW OF ELEVATION: 810.933

CITY OF RIVERSIDE, DEPARTMENT OF PUBLIC WORKS APPROVED BY DATE APPROVED BY PRINCIPAL ENGR. PARK DEPARTMENT DIRECTOR OF PUBLIC WORKS APPR. DATE TRAFFIC DIVISION REVISIONS CHIEF P.W.ENGR. DATE . DESIGNED BY CHECKED BY_ DRAWN BY_

FILE W/R-3471 IN THE CITY OF RIVERSIDE, COUNTY OF RIVERSIDE PROJECT NO. STATE OF CALIFORNIA AUTO CENTER RENOVATION PLAN SHEET ALVAREZ LINCOLN MERCURY 8051 AUTO CENTER DRIVE LIGHTING PLAN

FOR: RIVERSIDE AUTO CENTER ASSESSMENT DISTRICT INDEXED 12-26-01 44

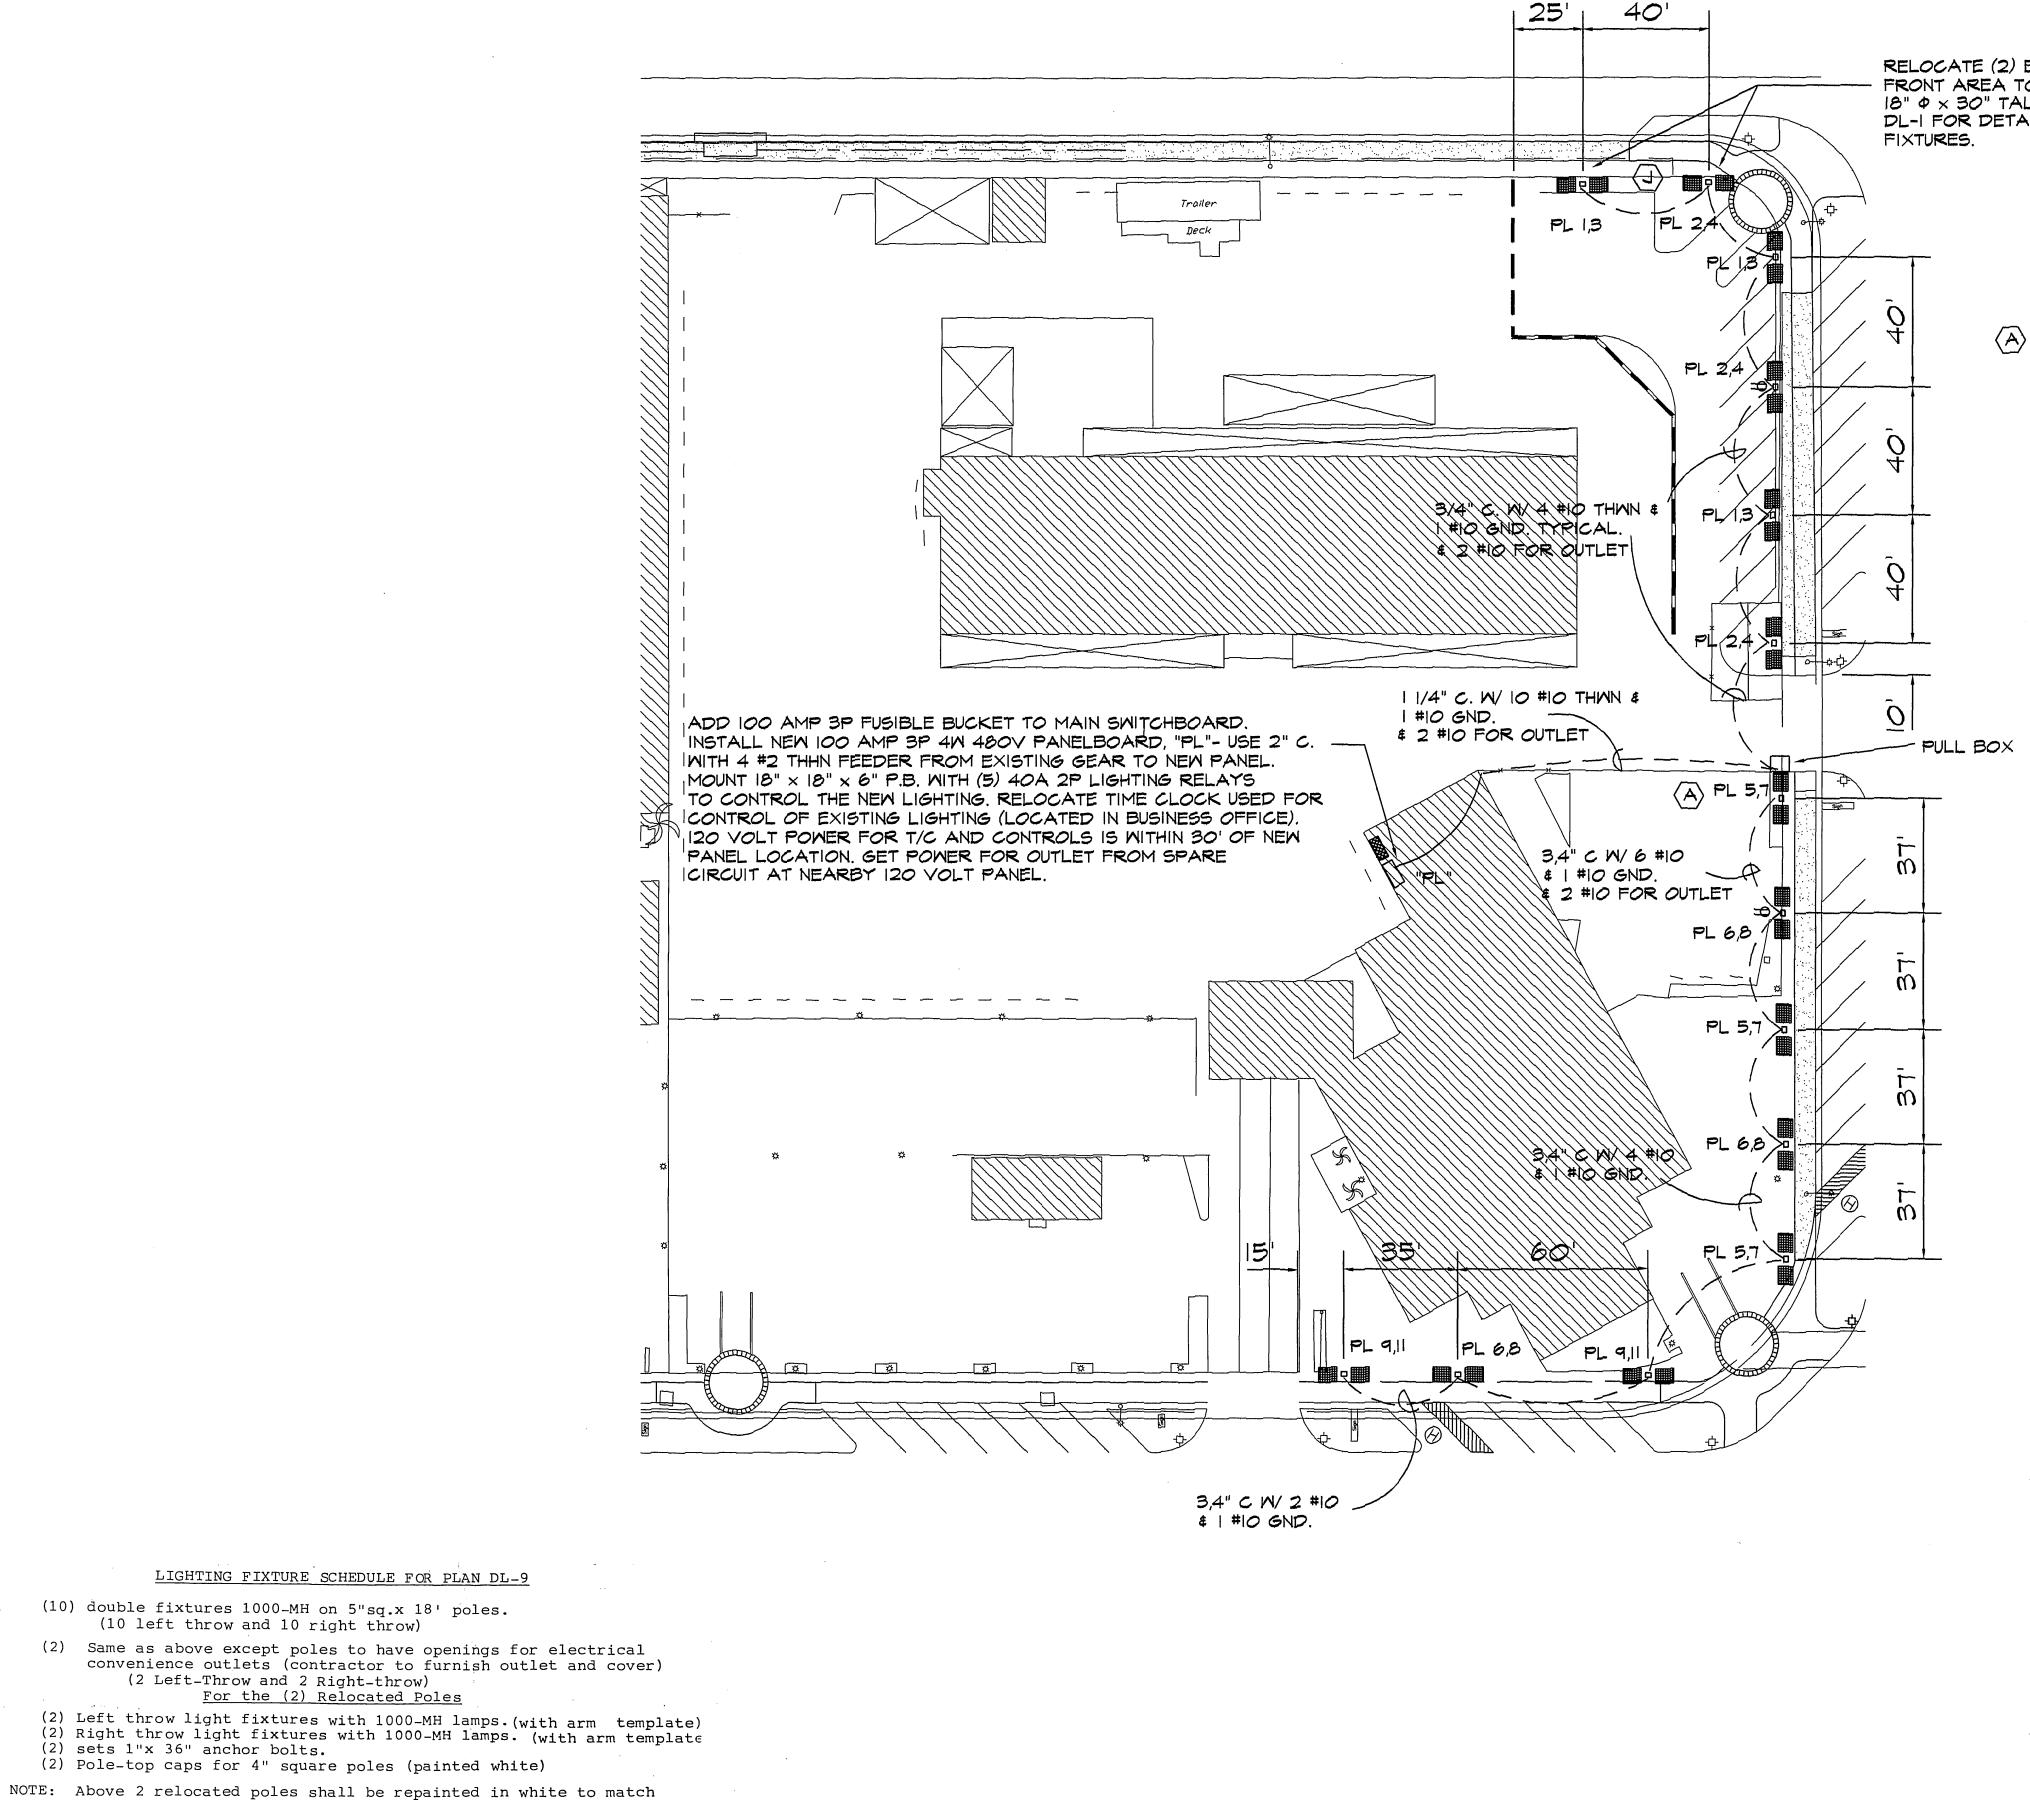

RELOCATE (2) EXISTING 4" SQ POLES FROM FRONT AREA TO NEW LOCATIONS, INSTALL NEW 18" $\phi \times$ 30" TALL CONCRETE BASES. SEE SHEET DL-I FOR DETAILS. INSTALL NEW FITTERS AND

> INSTALL (12) NEW 18" $\phi \times$ 30" TALL CONCRETE FOUNDATIONS WITH NEW POLES & FIXTURES.

EXISTING SWITCHBOARD

DISTRIE	BUTION BOARD	SECTION 1	OF	1		Bus:	277	/480	Volts				X Main	C.B.,	250 AN	ИP
Location	n: PARTS	Serving:	DISTRIE	BUTIO	N	з	Φ,	4	Wire,		400	AMP		Lugs Onl		
	Integrated Equipment SC Rating		Feed Thru Lugs									Flush M			Top Fe	
11	35,000 RMS SYM AMPS		SubFeed	d Lugs			<u> </u>	Iso. G	nd. Bu C.B.	IS	CONN	X Surface	Mnt.		X Bot. Fe	ed Load
Load Type	Circuit Description	n.	CONN	AMP	C.B.	СКТ	l PH	CKT	Pole	AMD	VA		Circuit De	ecription		Type
Type				 		CICI	FII		role	Aivii	VA		Oli Cult De	23CHPIIOH		11,700
ᅵᅵᅵ	OFFICE LIGHTING		4200		3	1	Α	2								
L	OFFICE LIGHTING		4200		3	3	В	4								
L	OFFICE LIGHTING		4200	40	3	- 5	С	6						<u> </u>		
M	AIR CONDITIONER #1		8310		3	7	Α	8	2	100	9000		TRANSFO			N
M	AIR CONDITIONER #1		8310	100	3	9	В	10	2	100	9000	PARTS	TRANSFO	ORMER		N
M	AIR CONDITIONER #1		8310	100	3	11	С	12								
M	AIR CONDITIONER #3		4200	70	3	13	Α	14	3	70	10000		AR OFFI			L
М	AIR CONDITIONER #3		4200	70	3	15	В	16	3	70	10000		AR OFFI	CE		L
M	AIR CONDITIONER #3		4200	70	3.	17	С	18	3	70	10000	USED C	AR OFFI	CE		L
	,						Α									
							В									
}							С									
L	PANEL PL		12840		3	25	Α									
L	PANEL PL		8568		3	27	В									
L	PANEL PL		8568		3	29	C									
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	Total Receptacle (R) Load @ 180VA/ea., 100% for first 10,000VA, & 50% Total Noncoincident (E) Load (Not included in demand load):					101 161	namuc							0.00 i		
	hting (L) Load @ 1.25%:	90.72 KV	-	l		Total N	NonCor	ntinuou	s (N) I	Load:				18.00 l		
_	otor (M) Load:	37.53 KV									emand loa	ad):	HP	0.00		
	OTAL CONNECTED LOAD:		AMP			A	В	С				EMAND LO	AD.			
'`	128.1	Κ\/Δ	Total /	Ф		175	160	127			146.3			176.0 A	4	
	120.1	17.4V	Total /	<u>~</u>		173	100	121			170.0	17477		170.07	•	

NEW PANELBOARD PL

PANE	L NO. PL	SECTION	1 OF	1		Bus:	277	/480	Volts				Main C.B.,		
Locatio		Serving:	LIGHTIN			3	Φ,	4	Wire,		225	AMP	X Main Lugs (
	Integrated Equipment SC Ra		Feed Th					1 0	 l D.			Flush M		X Top Fe	
Load	35,000 RMS SYM	M AMPS	SubFeed	d Lugs	C.B.		├	Iso. G	nd. Bu	us	CONN	X Surface	Mnt.	Bot. Fe	Lo
Type	Circuit Description	n	VA	AMP	Pole	СКТ	PH	СКТ	Pole	AMP	VA		Circuit Description	on	Ty
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ב ו	LIGHTING		3210	l	2	3	В	4	2	20	3210	1			
Ī	LIGHTING		3210		2	5	c	6	2	20	3210				l
L	LIGHTING		3210		2	7	A	8	2	20	3210				ī
L	LIGHTING		2148	20	2	9	В	10	1						
L	LIGHTING		2148	20	2	11	С	12	1				_		
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	•		1		1	19	A	20	1						
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					1	33	В	34	1						
					1	35	С	36	1_						
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					1	39	В	40	1						
			<u> </u>		1	41	С	42	1				_ <u>-</u>		<u></u>
Total N	eceptacle (R) Load @ 180VA	cluded in den	nand load):	0VA, 8	\$ 50% '				- AN 1				0.0	0 KVA 0 KVA 0 KVA	
	ighting (L) Load @ 1.25%: lotor (M) Load:	37.47 K 0 K				Total N					emand loa	aq).		0 KVA 0 KVA	
		<u> </u>				<u></u>			auue			·		O IXVA	_
I	OTAL CONNECTED LOAD:	10.74	AMP Total (Ф		A	В	C			37.5	EMAND LO		1 A	
	30.0	KVA	Total /	Ψ		46	31	31			37.5	KVA	45.	<u> </u>	

FILE W/R-3471 IN THE CITY OF RIVERSIDE, COUNTY OF RIVERSIDE PROJECT NO.

Underground Service Alert call: TOLL FREE TWO WORKING DAYS BEFORE YOU DIG

PRIVATE ENGINEERING NOTE

the new lights (contractor to furnish paint materials)

LIGHTING FIXTURE SCHEDULE FOR PLAN DL-9

(2 Left-Throw and 2 Right-throw)
For the (2) Relocated Poles

(2) Pole-top caps for 4" square poles (painted white)

Plan A (10) double fixtures 1000-MH on 5"sq.x 18' poles. (10 left throw and 10 right throw)

(2) sets 1"x 36" anchor bolts.

WEST COAST DESIGN ELECTRICAL AND LIGHTING ENGINEERS 26692 PASEO BRILLO, SLITE 200 SAN JUAN CAPISTRANO, CA 92675

(7/4) 240-1378 FAX 240-1782 DATE: MAY 1997

BENCH MARK: RIV. CO. BM 601-21-68, CALTRANS BRASS DISK SET IN CONC. WELL LOCATED IN CENTERLINE OF MONROE STREET 40' NW OF ELEVATION: 810.933 DESIGNED BY

DEPARTMENT OF PUBLIC WORKS APPROVED BY DATE APPROVED BY PRINCIPAL ENGR. PARK DEPARTMENT DIRECTOR OF PUBLIC WORKS APPR. DATE TRAFFIC DIVISION CHIEF P.W.ENGR.


REVISIONS

DRAWN BY_

CHECKED BY.

CITY OF RIVERSIDE,

STATE OF CALIFORNIA AUTO CENTER RENOVATION PLAN SHEET MULLER-HOOD BUICK 8001 AUTO CENTER DRIVE LIGHTING PLAN FOR: RIVERSIDE AUTO CENTER ASSESSMENT DISTRICT

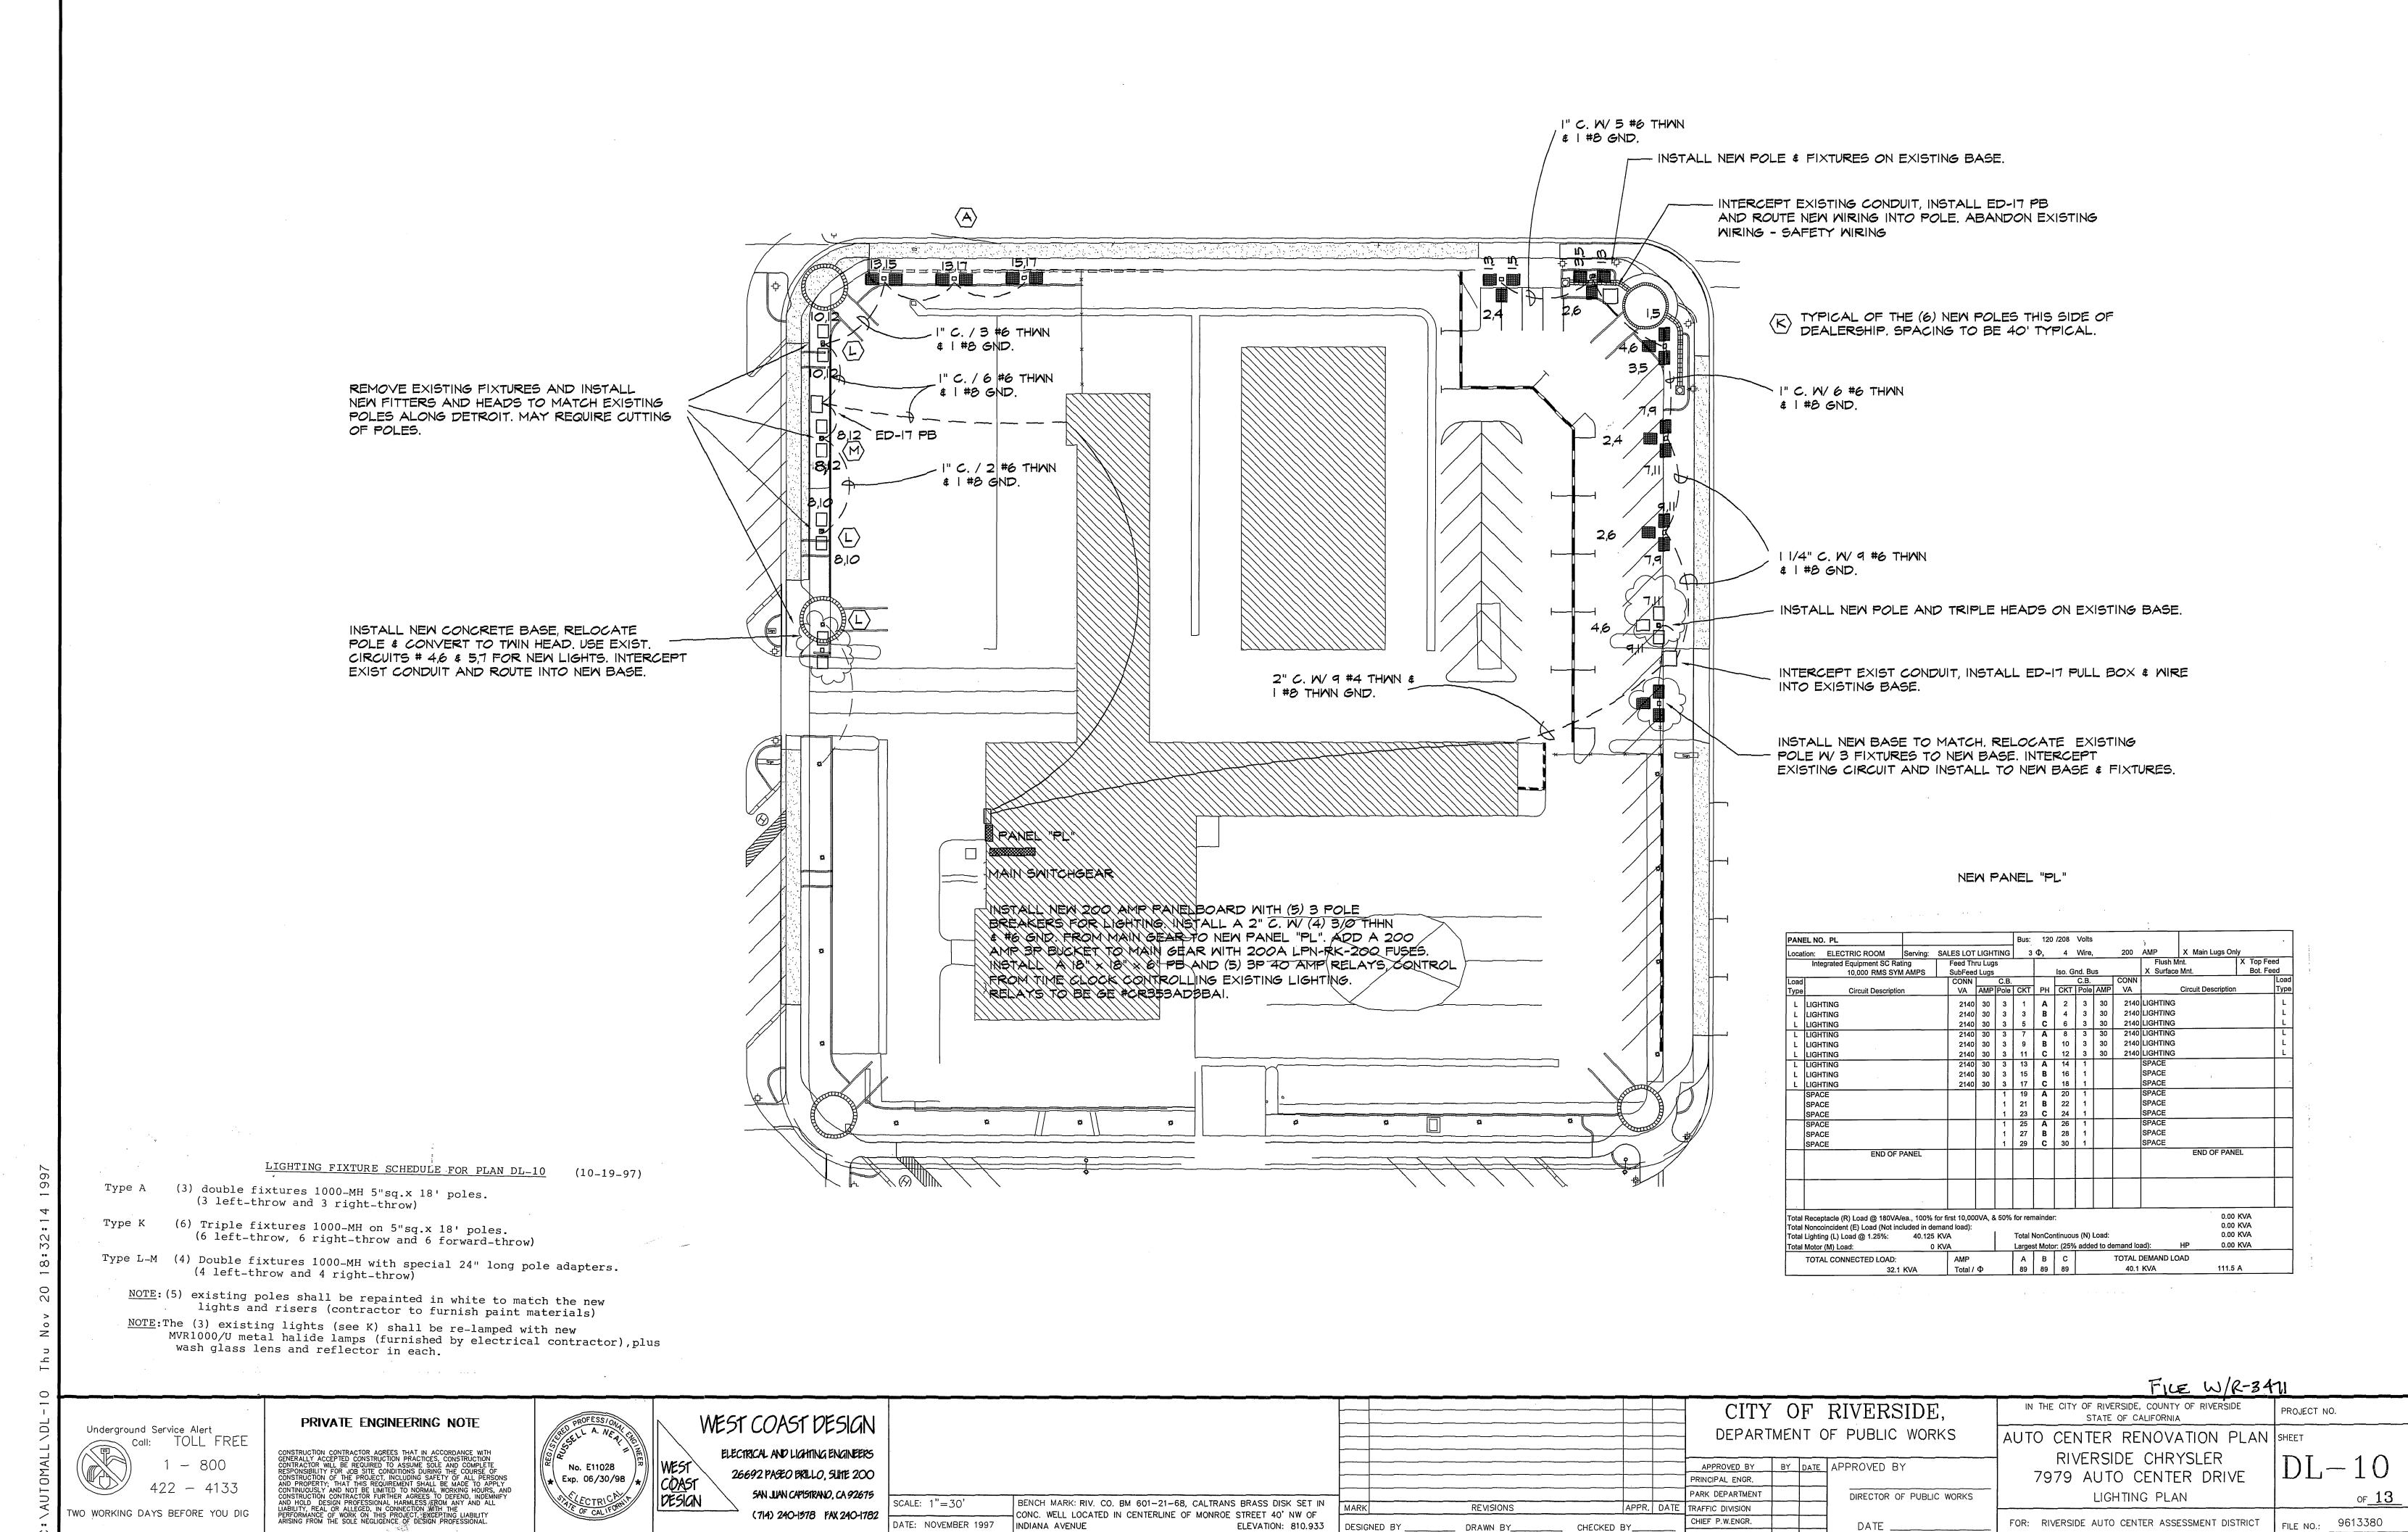

INDEXED 12-26-01 GH

** ENGINEERING NOTE: THE EXISTING FIXTURES ARE BEING REPLACED WITH NEW FIXTURES OF THE SAME WATTAGE. REUSE EXISTING CIRCUITS THERE WILL BE NO CHANGE IN PANEL SCHEDULES OR LOADS.


LIGHTING FIXTURE SCHEDULE FOR PLAN DL-11

Type E (6) Double fixtures 1000-MH with special 54" long pole risers (risers to be field-attached to existing round poles (6 left-throw reflectors and 6 right-throw reflectors)

NOTE: Above (6) existing poles shall be repainted in white to match the new lights and risers (contractor to furnish paint materials).

Underground Service Alert call: TOLL FREE

PRIVATE ENGINEERING NOTE

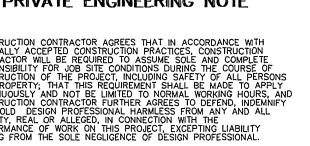

WEST COAST DESIGN

ELECTRICAL AND LIGHTING ENGINEERS 26692 PASEO BRILLO, SLIME 200 SAN JUAN CAPISTRANO, CA 92675 (714) 240-1378 FAX 240-1782 DATE

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ALE:	1"=20'	BENCH MARK: RIV. CO. BM 601-21-68, CALTRANS CONC. WELL LOCATED IN CENTERLINE OF MONROE		MARK	
TE:	APRIL 1997		ELEVATION: 810.933	DESIG	NED BY _

	 CITY	0	F	RIVERS	SIDE,
	 DEPART	MEN	IT C	F PUBLIC	WORKS
	 APPROVED BY	BY	DATE	APPROVED E	3Y
	 PRINCIPAL ENGR.				

REVISIONS


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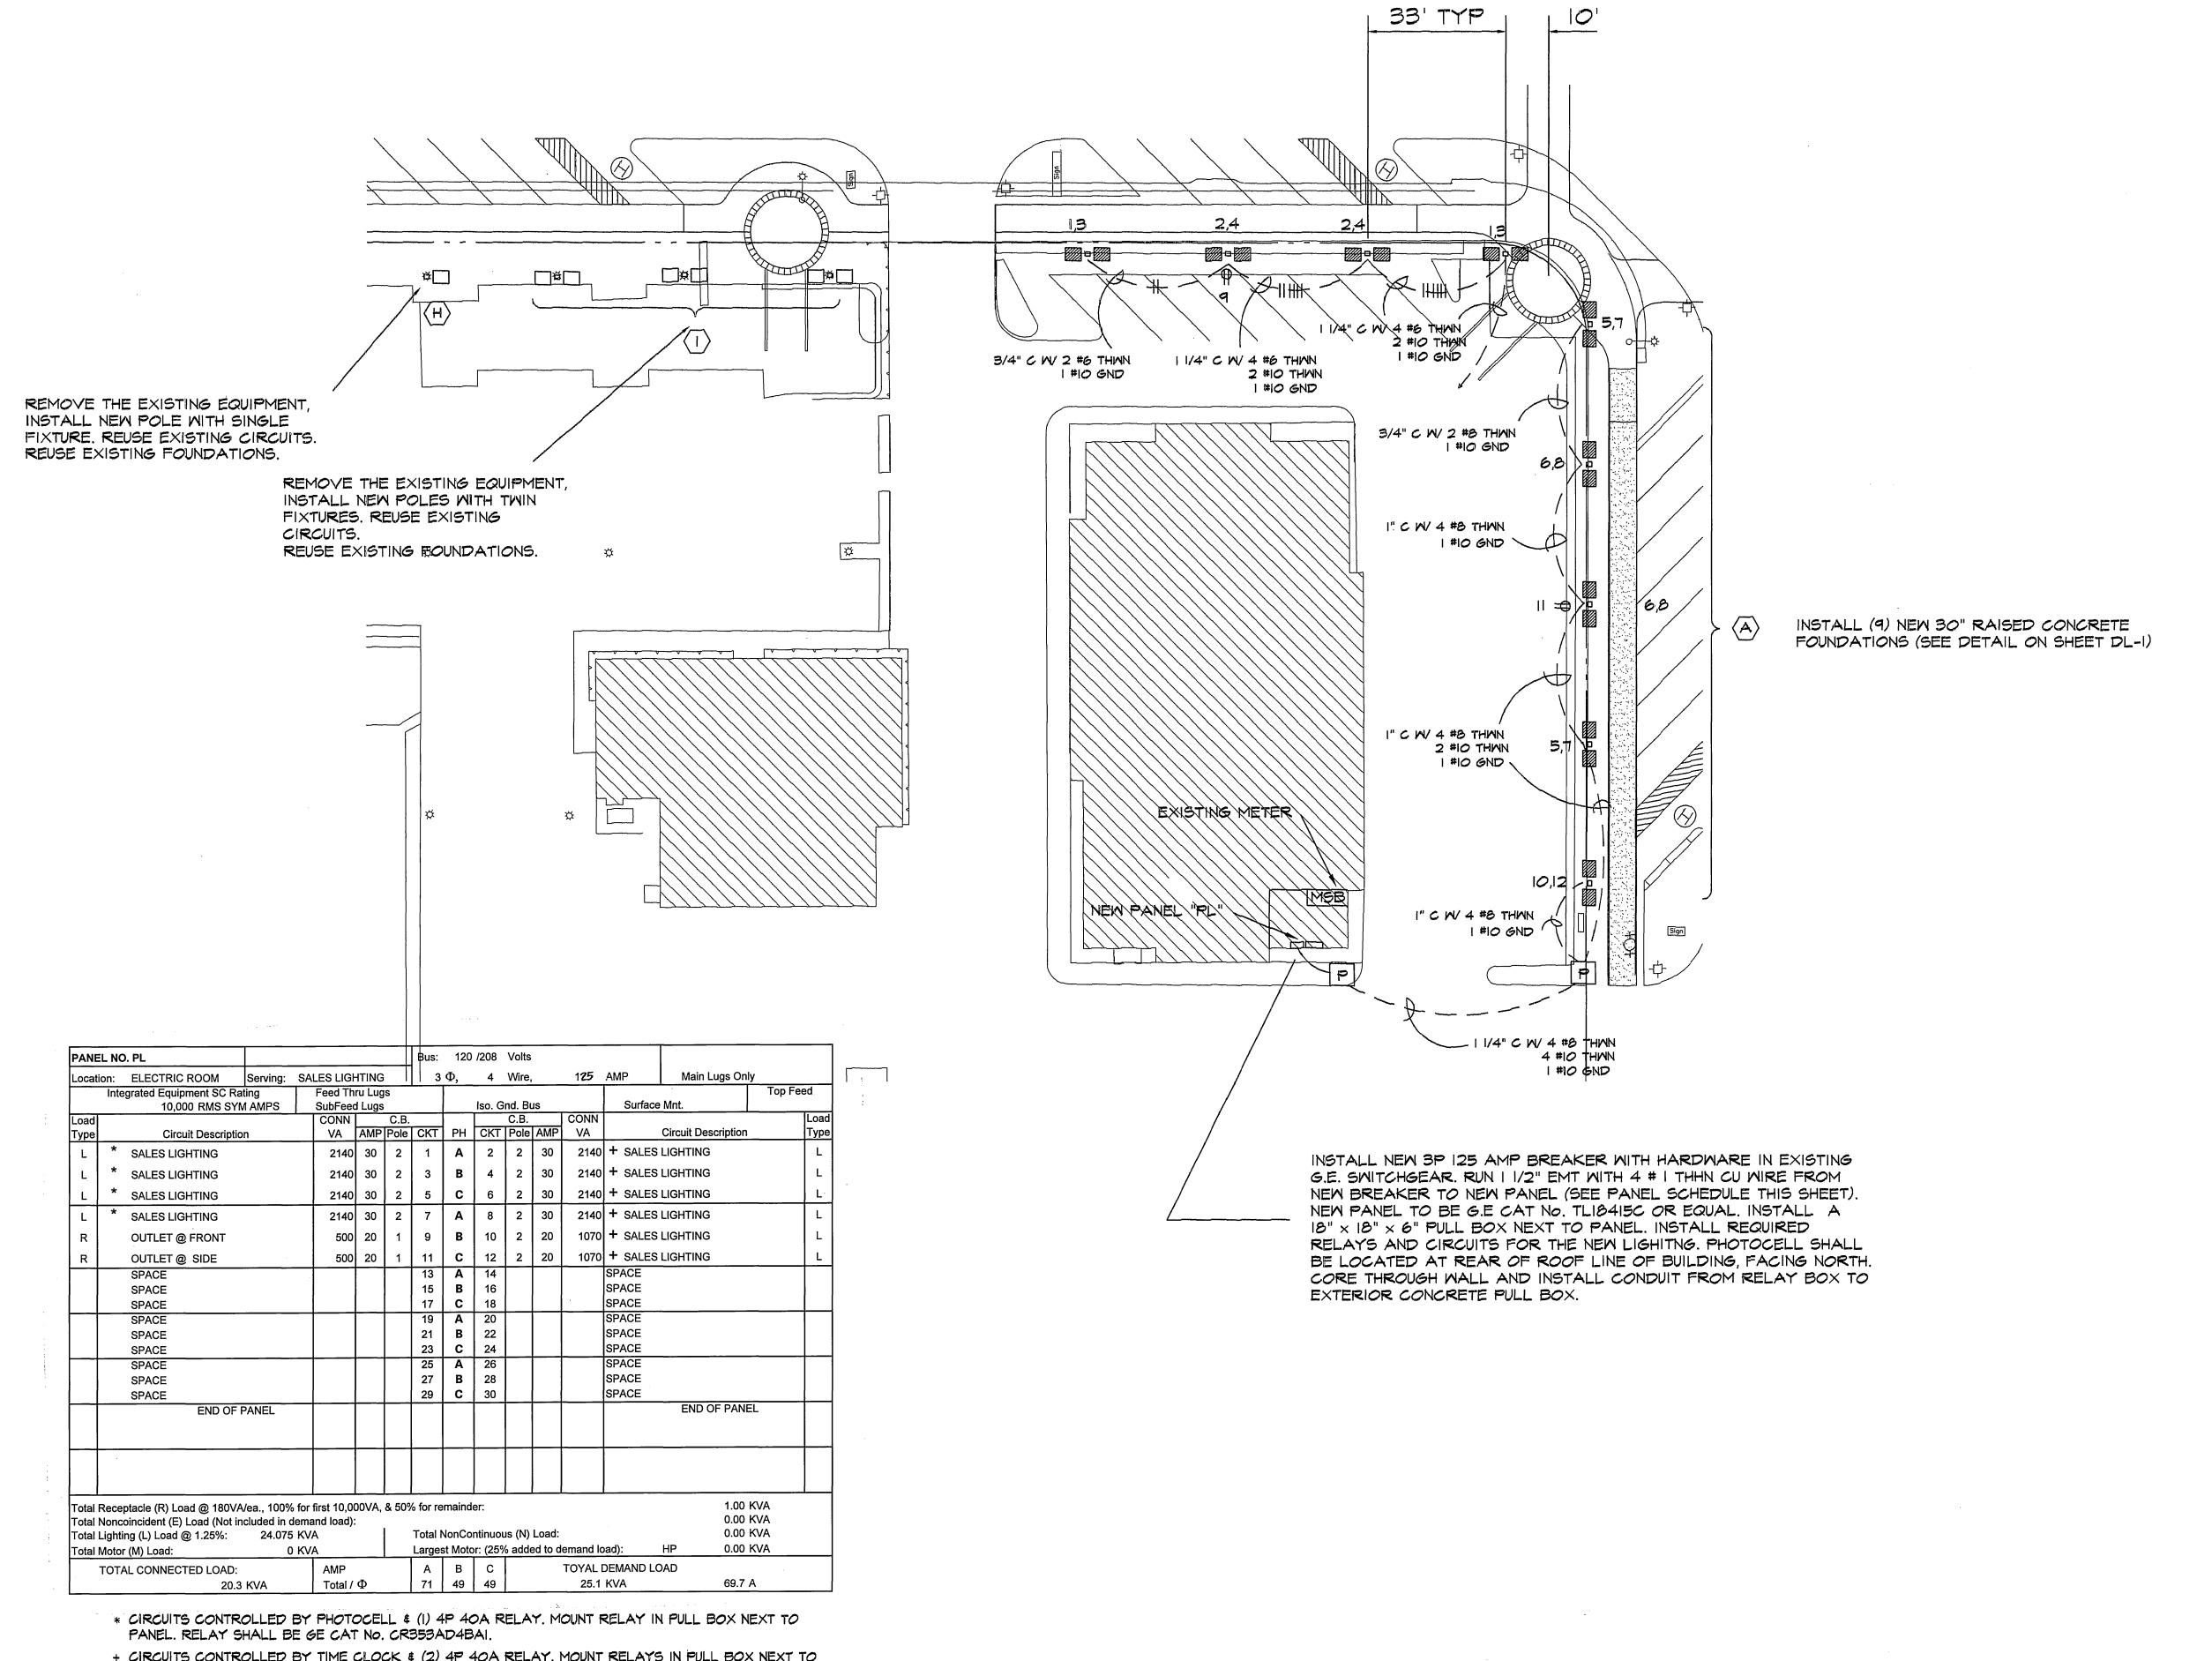
CHECKED BY_

FILE W/R-3471 IN THE CITY OF RIVERSIDE, COUNTY OF RIVERSIDE STATE OF CALIFORNIA PARK DEPARTMENT DIRECTOR OF PUBLIC WORKS LIGHTING PLAN APPR. DATE TRAFFIC DIVISION

AUTO CENTER RENOVATION PLAN SHEET TOYOTA TRUCK LOT 7877 INDIANA AVE. FILE NO.: 9613380 FOR: RIVERSIDE AUTO CENTER ASSESSMENT DISTRICT

PROJECT NO.



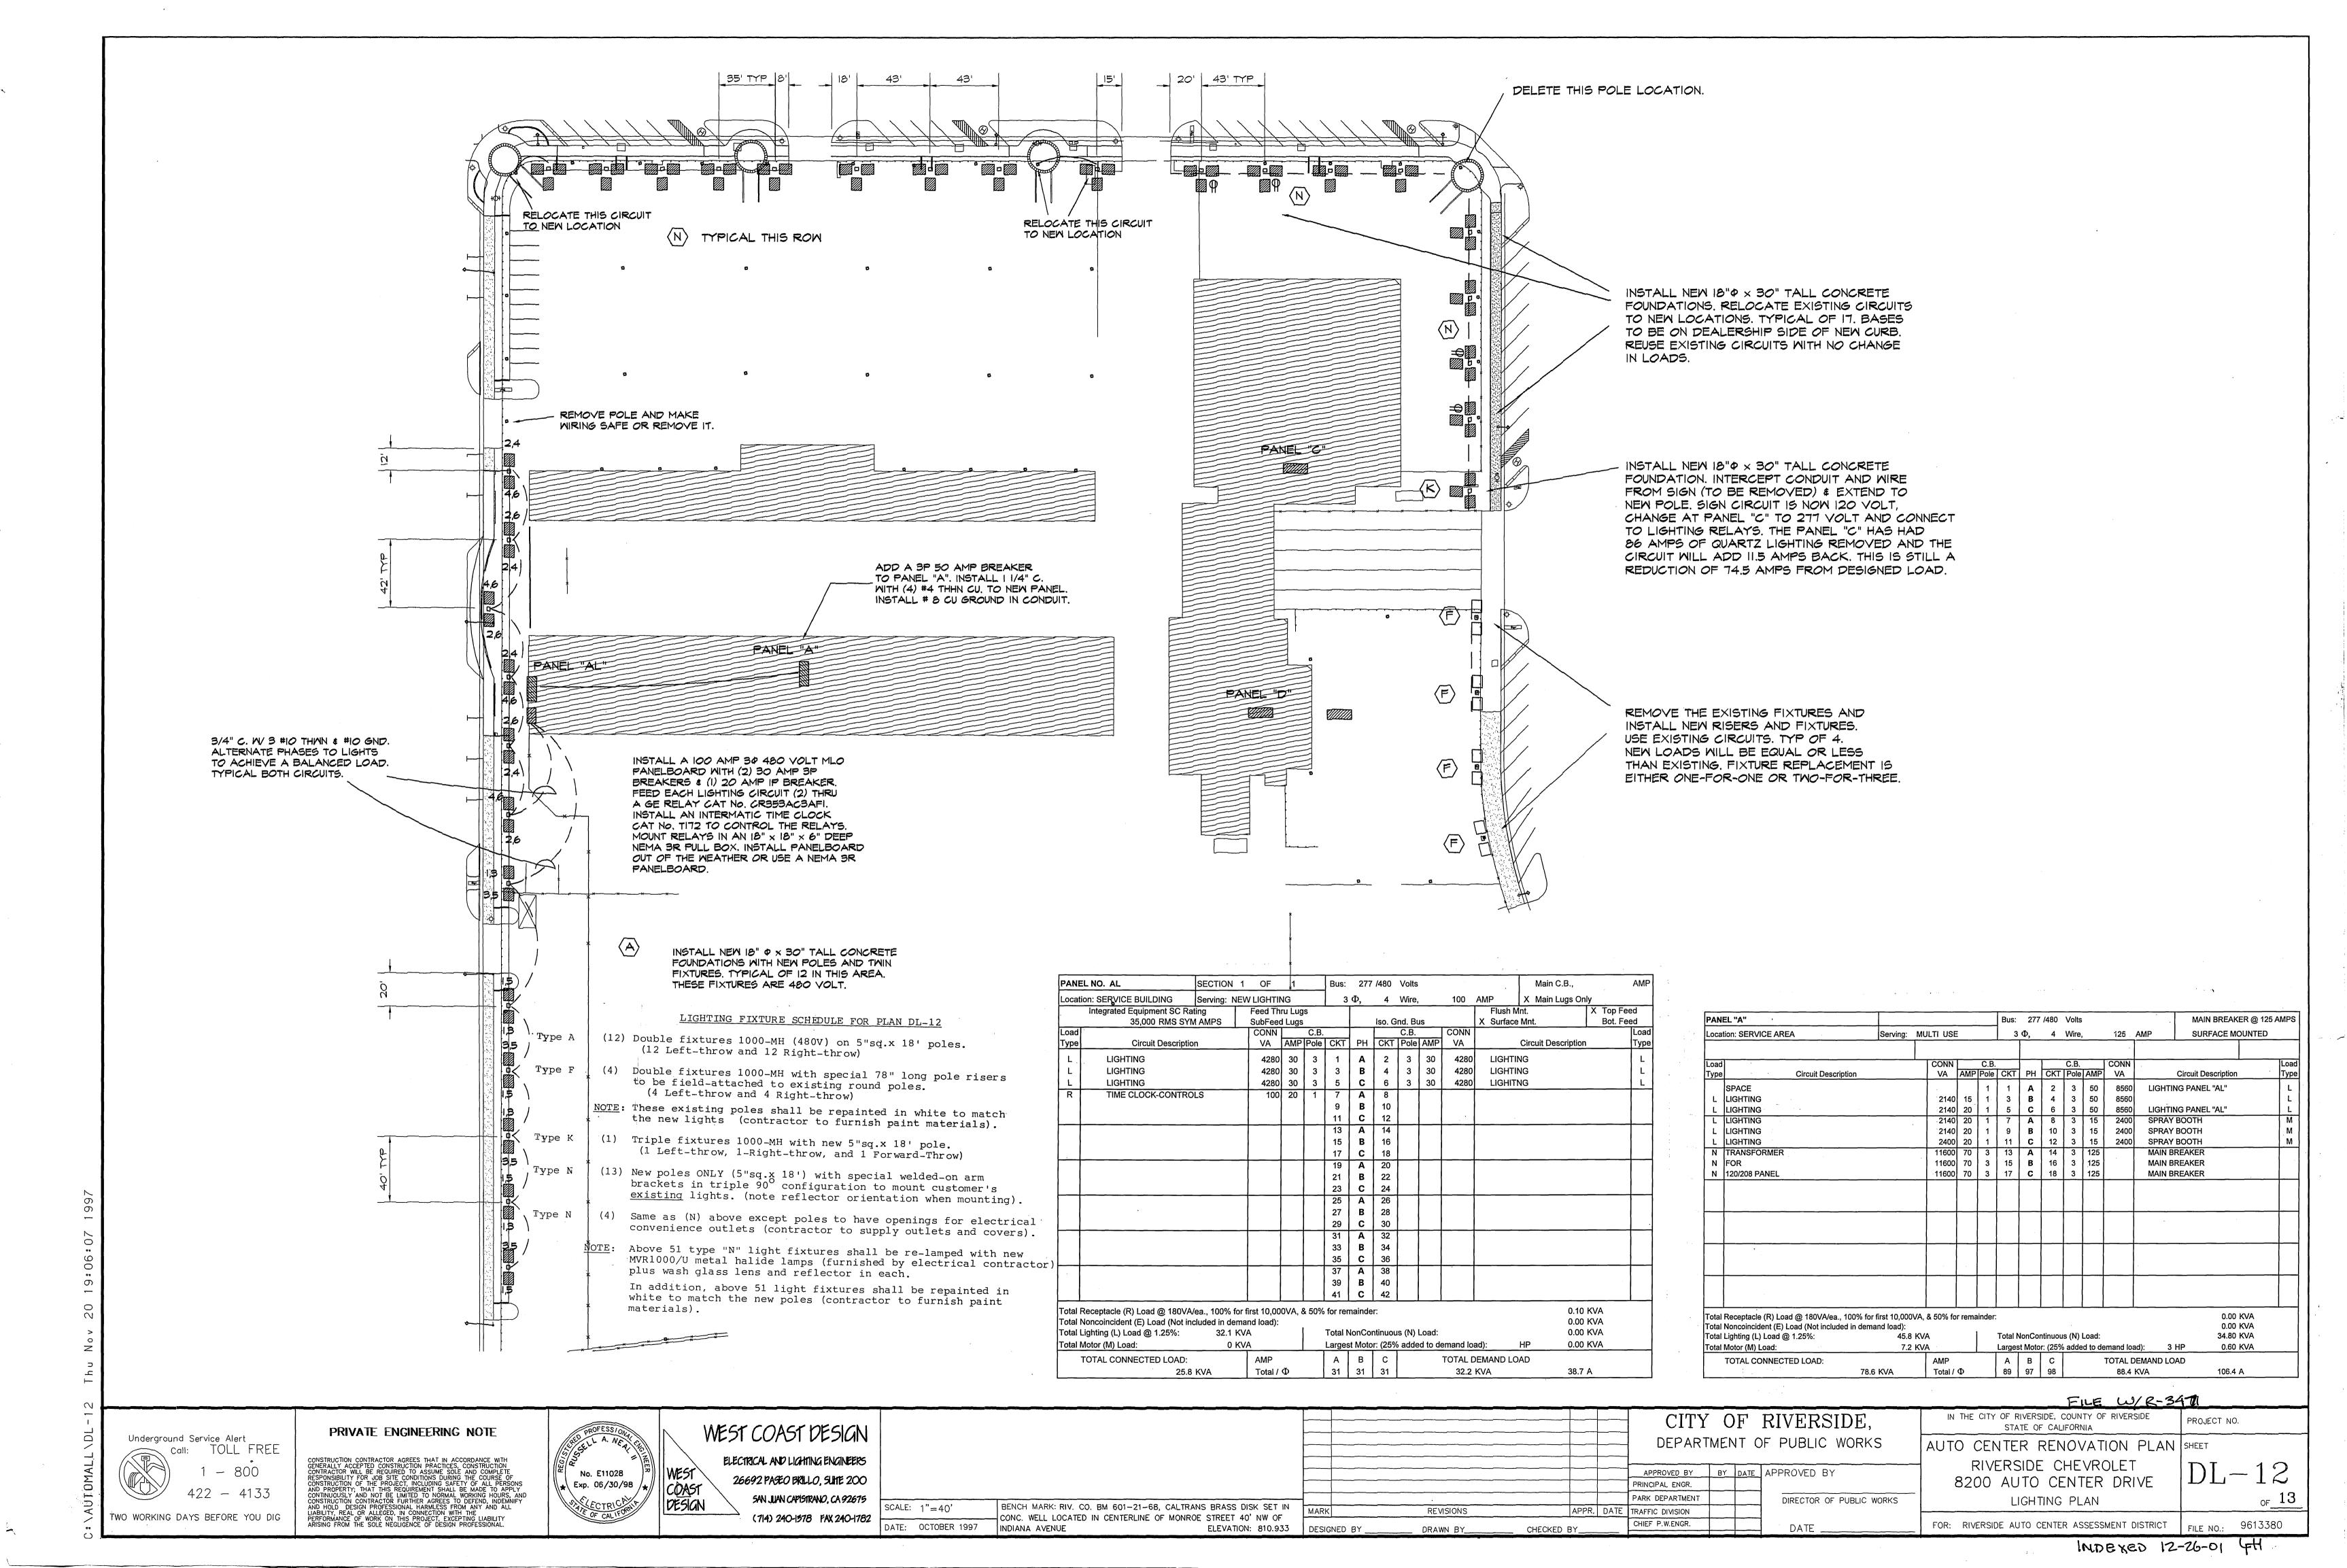

+ CIRCUITS CONTROLLED BY TIME CLOCK \$ (2) 4P 40A RELAY. MOUNT RELAYS IN PULL BOX NEXT TO PANEL. RELAYS SHALL BE GE CAT No. CR353AD4BAI. USE INTERMATIC T-101 OR RQUAL.

FILE W/R-3471

IN THE CITY OF RIVERSIDE, COUNTY OF RIVERSIDE STATE OF CALIFORNIA

Underground Service Alert Call: TOLL FREE TWO WORKING DAYS BEFORE YOU DIG

PRIVATE ENGINEERING NOTE

CONSTRUCTION CONTRACTOR AGREES THAT IN ACCORDANCE WITH GENERALLY ACCEPTED CONSTRUCTION PRACTICES, CONSTRUCTION CONTRACTOR WILL BE REQUIRED TO ASSUME SOLE AND COMPLETE RESPONSIBILITY FOR JOB SITE CONDITIONS DURING THE COURSE OF CONSTRUCTION OF THE PROJECT, INCLUDING SAFETY OF ALL PERSONS AND PROPERTY; THAT THIS REQUIREMENT SHALL BE MADE TO APPLY CONTINUOUSLY AND NOT BE LIMITED TO NORMAL WORKING HOURS, AND CONSTRUCTION CONTRACTOR FURTHER AGREES TO DEFEND, INDEMNIFY AND HOLD DESIGN PROFESSIONAL HARMLESS FROM ANY AND ALL LIABILITY, REAL OR ALLEGED, IN CONNECTION WITH THE PERFORMANCE OF WORK ON THIS PROJECT, EXCEPTING LIABILITY ARISING FROM THE SOLE NEGLIGENCE OF DESIGN PROFESSIONAL.

★ Exp. 06/30/98 /★/

WEST COAST DESIGN ELECTRICAL AND LIGHTING ENGINEERS 26692 PASEO BRILLO, SUITE 200 SAN JUAN CAPISTRANO, CA 92675 DESIGN (714) 240-1578 FAX 240-1782

BENCH MARK: RIV. CO. BM 601-21-68, CALTRANS BRASS DISK SET IN CONC. WELL LOCATED IN CENTERLINE OF MONROE STREET 40' NW OF DATE: OCTOBER 1997 INDIANA AVENUE

ELEVATION: 810.933 DESIGNED BY

PRINCIPAL ENGR. PARK DEPARTMENT APPR. DATE TRAFFIC DIVISION CHIEF P.W.ENGR. DRAWN BY CHECKED BY

DEPARTMENT OF PUBLIC WORKS AUTO CENTER RENOVATION PLAN SHEET MITSUBISHI DEALERSHIP APPROVED BY DATE APPROVED BY 8100 AUTO CENTER DRIVE DIRECTOR OF PUBLIC WORKS LIGHTING PLAN FOR: RIVERSIDE AUTO CENTER ASSESSMENT DISTRICT DATE

CITY OF RIVERSIDE,

FILE NO.: 9613380 INDEXED 12-26-01 4H

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